

NELSON

SITE AREA ±757,233 SF (±17.38 ACRES)

BUILDING AREAS: BLDG A - 169,612 SF BLDG B - 133,819 SF

BUILDING A

PARKING:

34 STALLS - (5%) 8,481 SF OFFICE @ 1/250 SF 47 STALLS - (95%) 161,131 SF WHSE

81 TOTAL STALLS REQUIRED

1.09 PARKING RATIO PROVIDED

BUILDING B

1/250 SF 37 STALLS - (95%) 127,128 SF WHSE @ 1/3,500 SF

80 TOTAL STALLS PROVIDED 1.25 PARKING RATIO PROVIDED

DOCK DOORS

INDUSTRIAL

@ 1/3,500 SF

88 TOTAL STALLS PROVIDED

27 STALLS - (5%) 6,691 SF OFFICE @ 64 TOTAL STALLS REQUIRED

27 BUILDING "A"

DOCK DOORS 26 BUILDING "B"

Nelco Architecture, Inc.

1200 Fifth Ave. Suite 1300 Seattle, WA 98101 Phone: (206) 408-8500 WWW.NELSONWORLDWIDE.COM

BRIDGE

DEVELOPMENT **PARTNERS** 10655 NE 4TH STREET, SUITE 210 BELLEVUE, WASHINGTON, 98004

MAYWOOD ELEMENTARY SITE


BRIDGE

1410 SOUTH 200TH STREET SEATAC, WA 98198

PRELIMINARY SITE PLAN REVIEW 07/20/2021 05/27/2022 RESPONSE TO COMMENTS

ARCHITECTURAL SITE PLAN

Proj. No: 20.0003230 JC Reviewed By:ER/ME

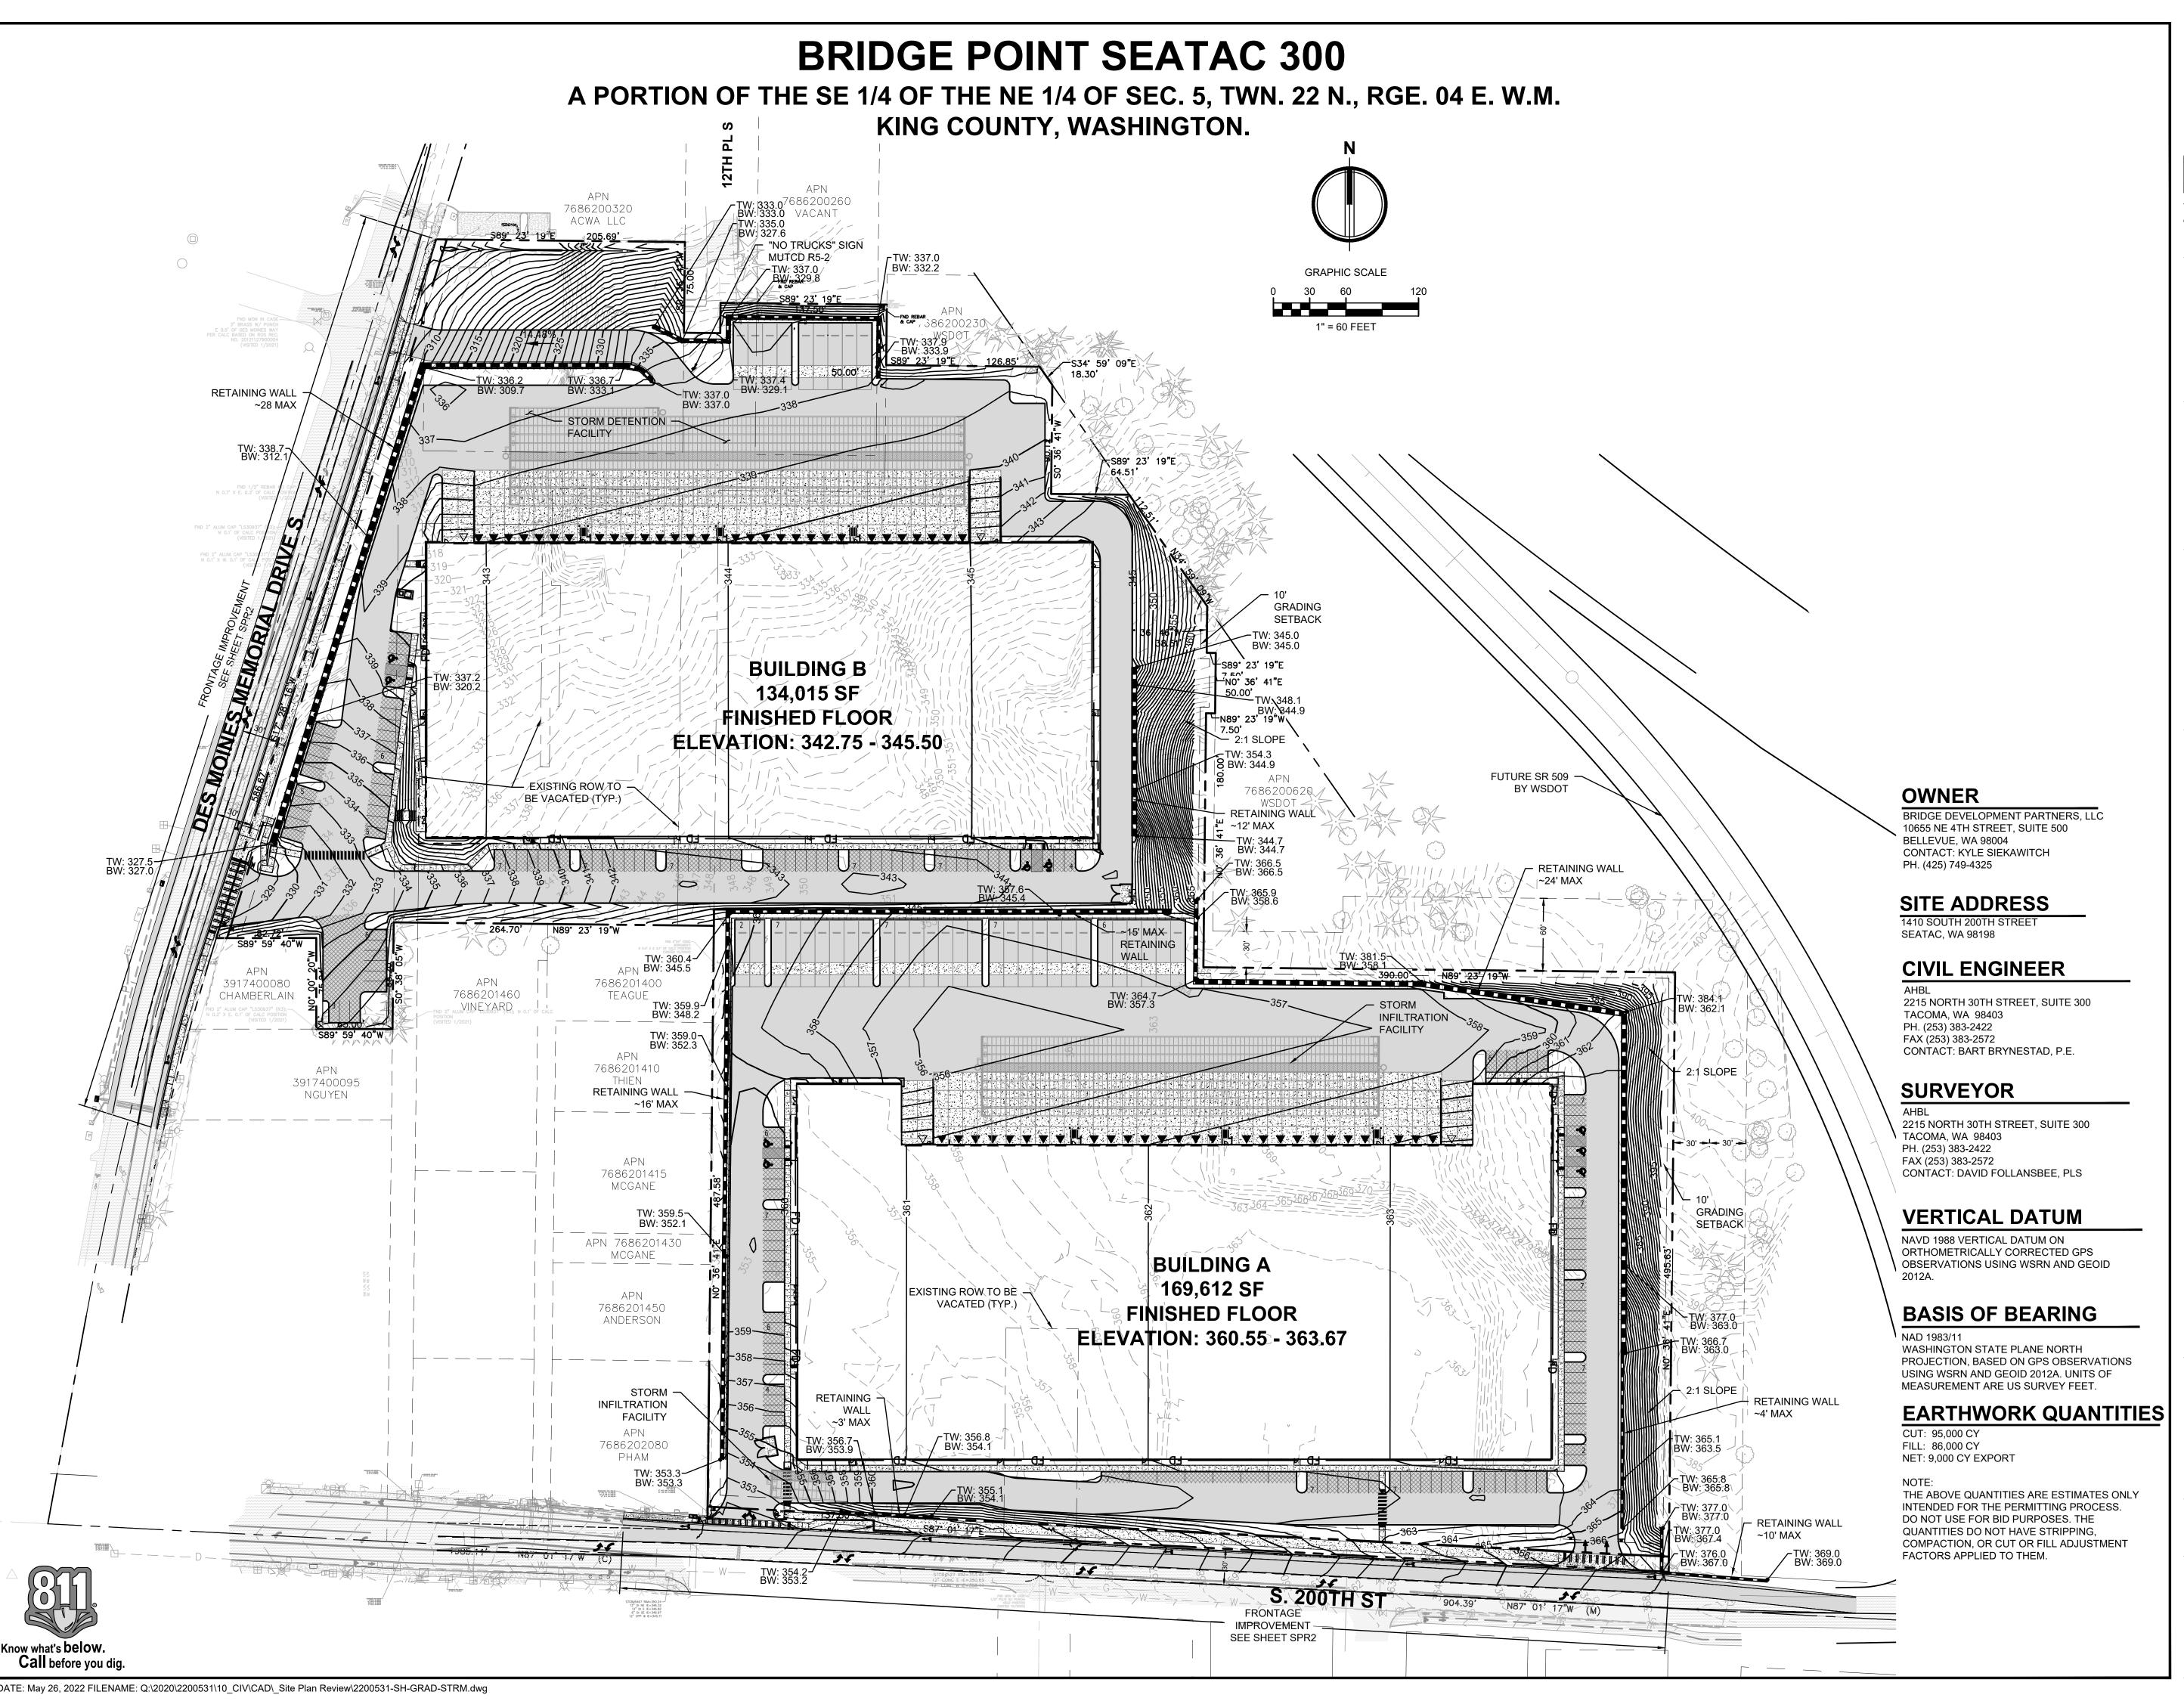



2215 North 30th Street, Suite 300, Tacoma, WA 98403 253.383.2422 TEL 253.383.2572 FAX www.ahbl.com WEB

Project Title:

BRIDGE POINT SEATAC 300

BRIDGE DEVELOPMENT PARTNERS, LLC

> 10655 NE 4TH STREET, SUITE 500 BELLEVUE, WA 98004 KYLE SIEKAWITCH PH: (425) 749-4325

<u>Project No.</u>


2200531.10

Issue Set & Date:

SITE PLAN REVIEW

5/25/2022



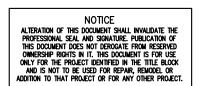

REVISED 5/25/2022 PER CITY OF SEATAC COMMENTS DATED 3/29/2022

REVISED 2/24/2022 PER CITY OF SEATAC 3 COMMENTS DATED 1/14/2022

REVISED 10/13/2021 PER CITY OF SEATAC 2 COMMENTS DATED 9/3/2021

REVISED 7/16/2021 PER CITY OF SEATAC Revisions:

Sheet Title:

PRELIMINARY GRADING AND DRAINAGE PLAN


Designed by: Drawn by: Checked by:

Sheet No.

1 of 3 Sheets

BRIDGE POINT SEATAC 300

A PORTION OF THE SE 1/4 OF THE NE 1/4 OF SEC. 5, TWN. 22 N., RGE. 04 E. W.M. KING COUNTY, WASHINGTON.

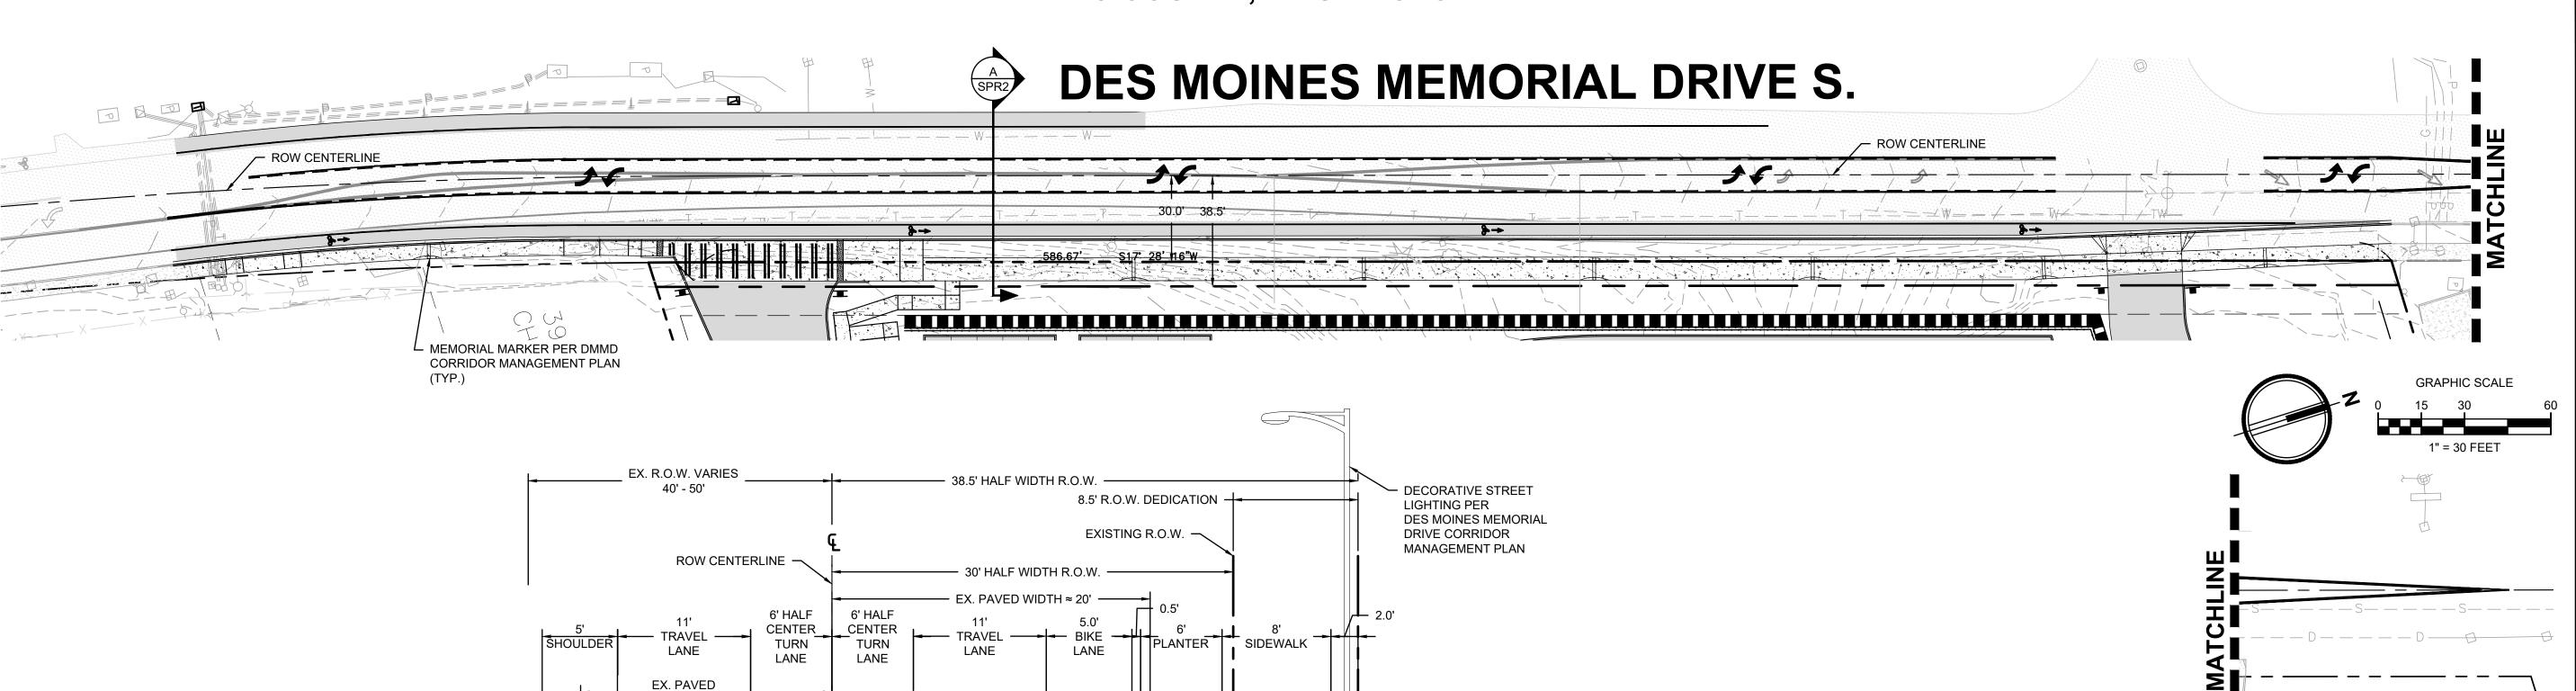


DECORATIVE STAMPED


DES MOINES MEMORIAL DRIVE CORRIDOR MANAGEMENT PLAN

CONCRETE PER



WIDTH VARIES

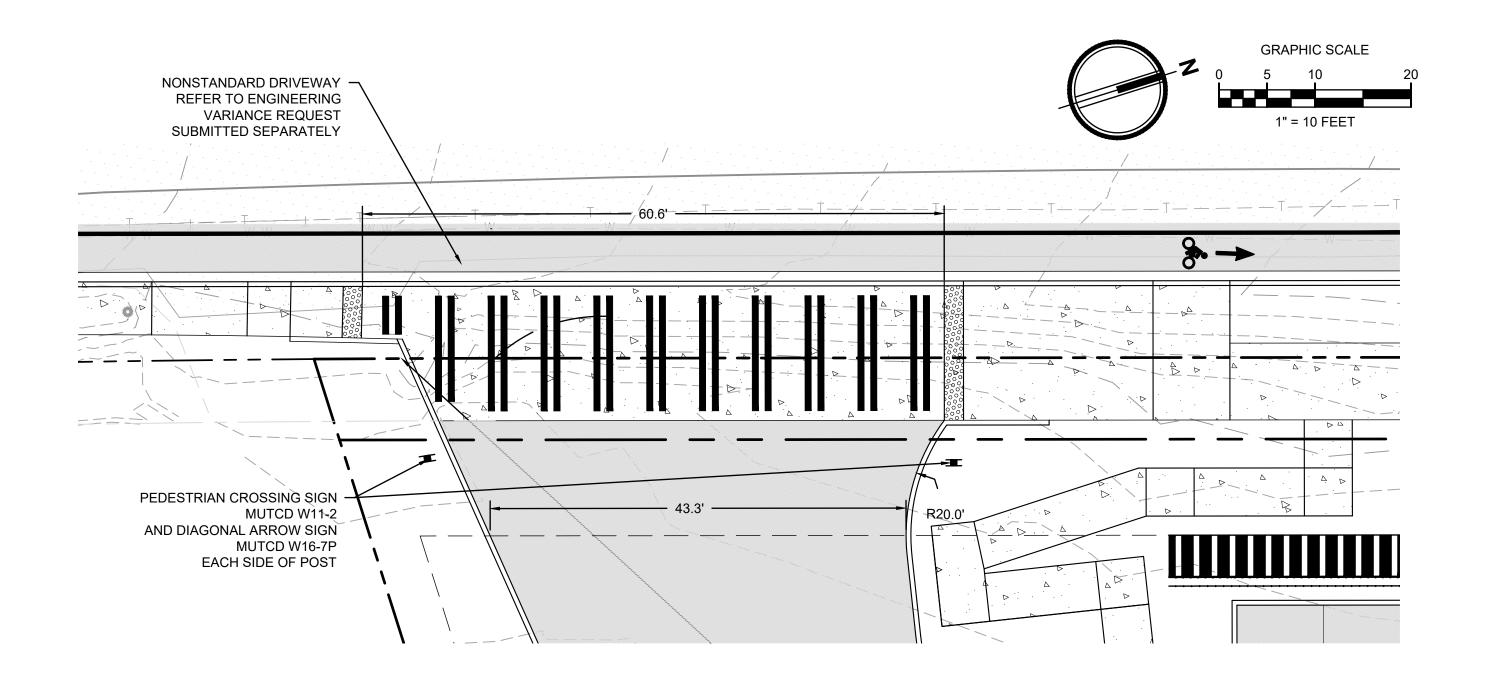

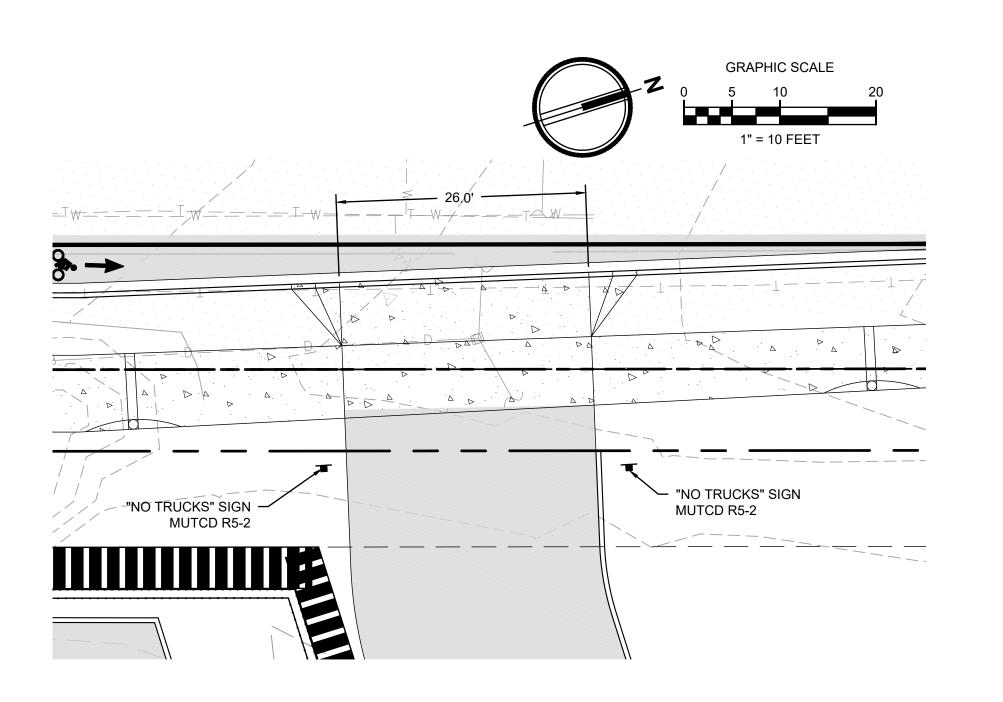



2215 North 30th Street, Suite 300, Tacoma, WA 98403

253.383.2422 TEL 253.383.2572 FAX www.ahbl.com WEB

Project Title:

BRIDGE POINT SEATAC 300

BRIDGE DEVELOPMENT PARTNERS, LLC

> 10655 NE 4TH STREET, SUITE 500 BELLEVUE. WA 98004 KYLE SIEKAWITCH PH: (425) 749-4325

<u>Project No.</u>


2200531.10

Issue Set & Date:

SITE PLAN REVIEW

5/25/2022



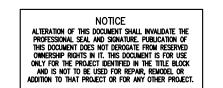

REVISED 5/25/2022 PER CITY OF SEATAC COMMENTS DATED 3/29/2022

REVISED 2/24/2022 PER CITY OF SEATAC

REVISED 10/13/2021 PER CITY OF SEATAC **2** COMMENTS DATED 9/3/2021

REVISED 7/16/2021 PER CITY OF SEATAC

Sheet Title:

DES MOINES MEMORIAL DRIVE IMPROVEMENTS


Designed by: Drawn by: Checked by:

Sheet No.

SPR2

2 of 3 Sheets



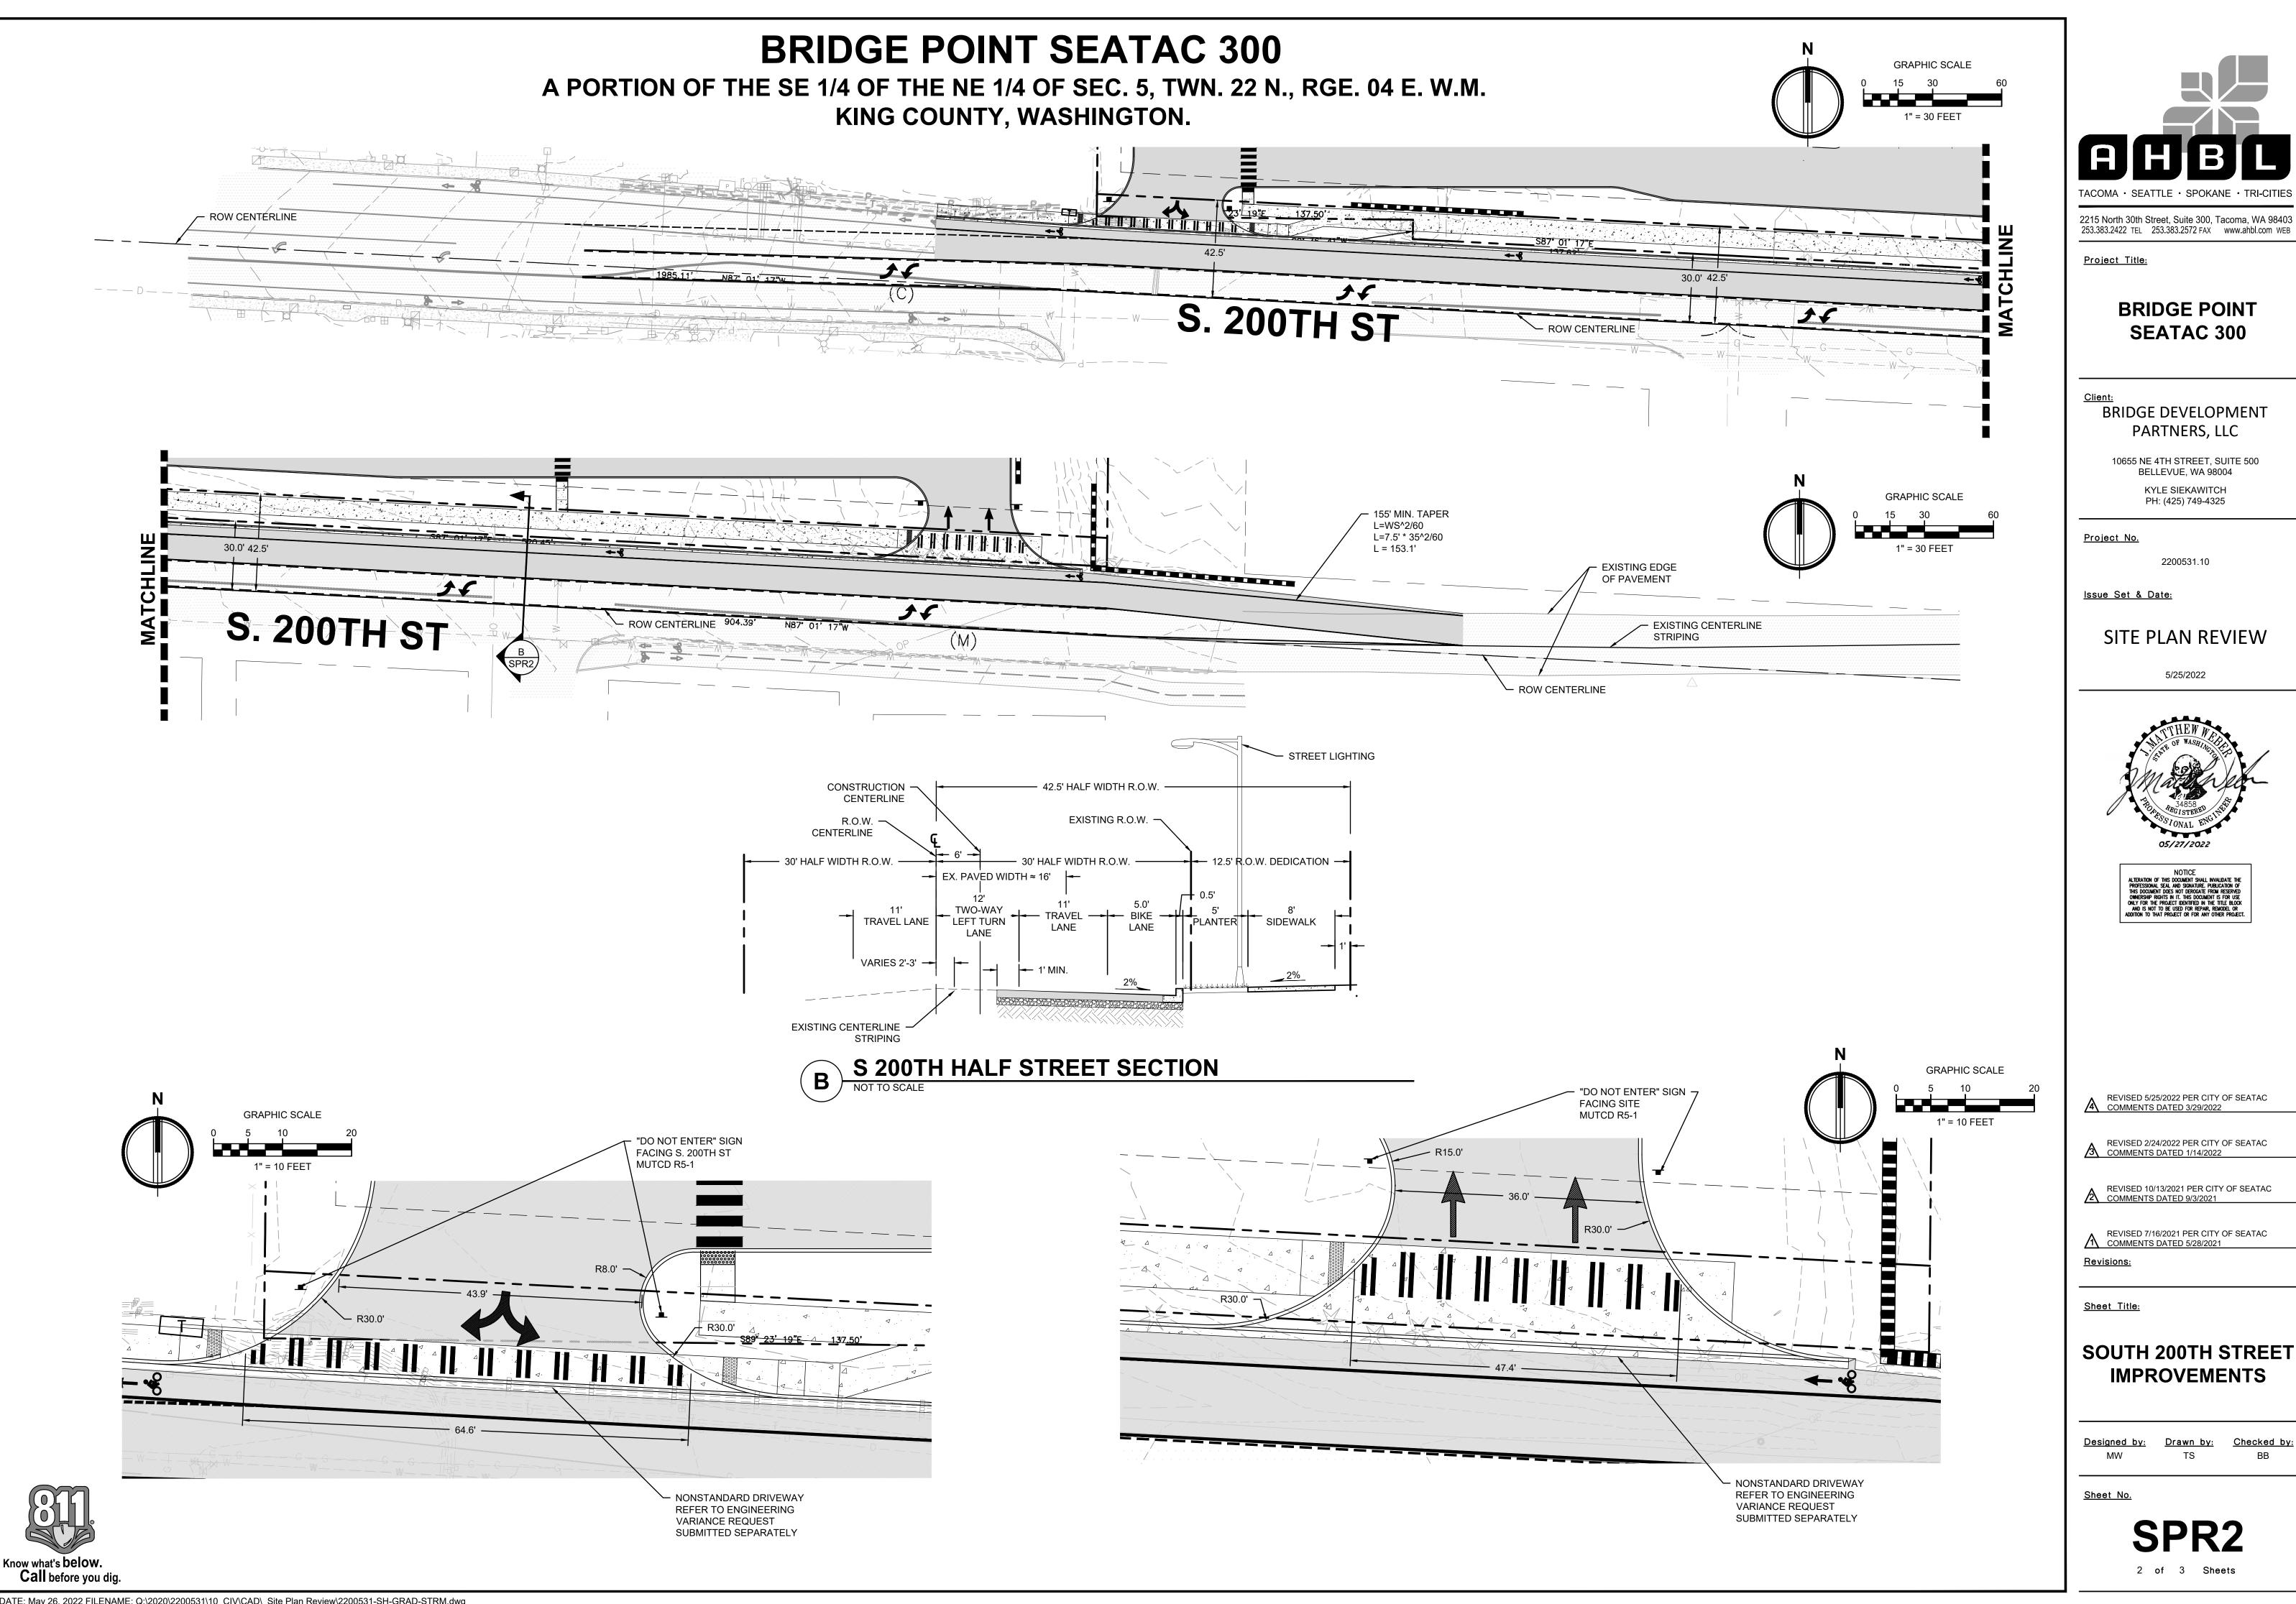

BRIDGE POINT SEATAC 300

BRIDGE DEVELOPMENT PARTNERS, LLC

10655 NE 4TH STREET, SUITE 500 BELLEVUE, WA 98004 KYLE SIEKAWITCH PH: (425) 749-4325

<u>Project No.</u>

2200531.10

Issue Set & Date:

SITE PLAN REVIEW

5/25/2022





REVISED 5/25/2022 PER CITY OF SEATAC COMMENTS DATED 3/29/2022

REVISED 2/24/2022 PER CITY OF SEATAC COMMENTS DATED 1/14/2022

REVISED 10/13/2021 PER CITY OF SEATAC COMMENTS DATED 9/3/2021

REVISED 7/16/2021 PER CITY OF SEATAC COMMENTS DATED 5/28/2021

<u>Revisions:</u>

Sheet Title:


SOUTH 200TH STREET IMPROVEMENTS

Designed by: Drawn by: Checked by:

Sheet No.

SPR2

2 of 3 Sheets

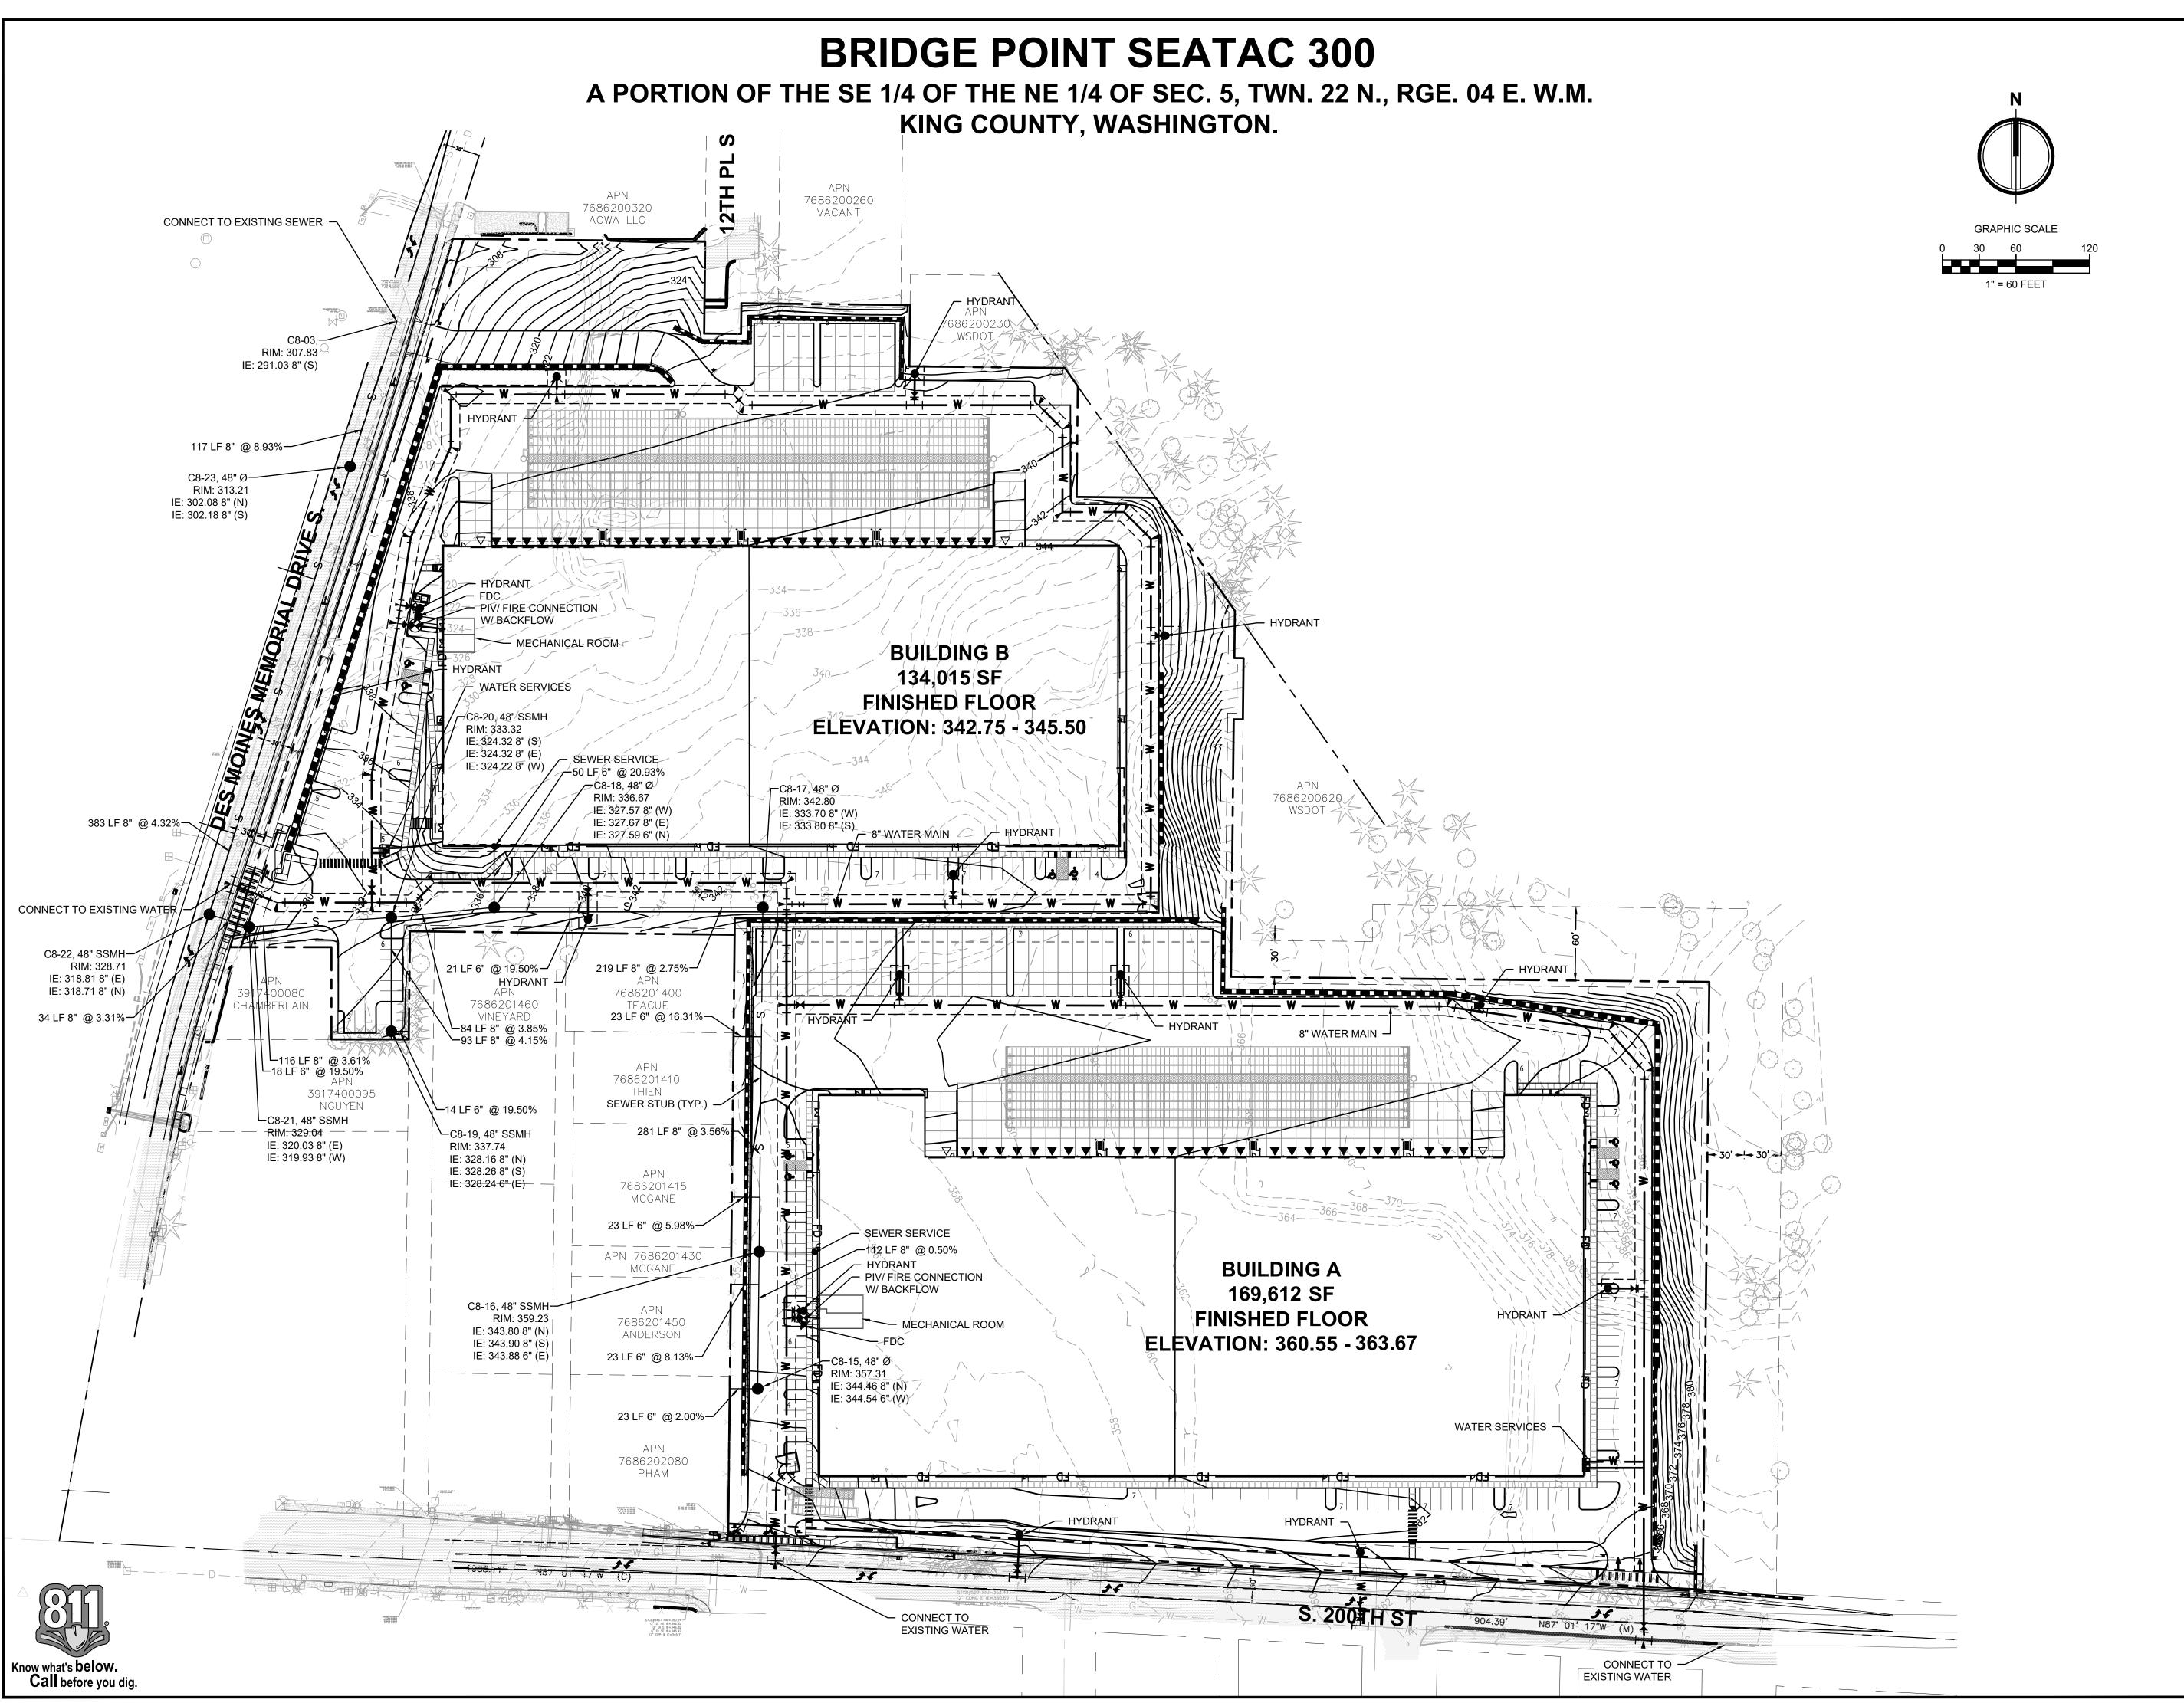



BRIDGE POINT SEATAC 300

BRIDGE DEVELOPMENT PARTNERS, LLC

> 10655 NE 4TH STREET, SUITE 500 BELLEVUE, WA 98004 KYLE SIEKAWITCH PH: (425) 749-4325

<u>Project No.</u>


2200531.10

Issue Set & Date:

SITE PLAN REVIEW

5/25/2022



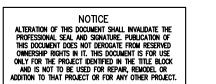

REVISED 5/25/2022 PER CITY OF SEATAC COMMENTS DATED 3/29/2022

REVISED 2/24/2022 PER CITY OF SEATAC COMMENTS DATED 1/14/2022

REVISED 10/13/2021 PER CITY OF SEATAC COMMENTS DATED 9/3/2021

REVISED 7/16/2021 PER CITY OF SEATAC

Sheet Title:

PRELIMINARY UTILITY PLAN

Designed by: Drawn by: Checked by:

Sheet No.

3 of 3 Sheets

DATE: May 19, 2022 FILENAME: Q:\2020\2200531\10 CIV\CAD\ Site Plan Review\2200531-SH-UTIL.dwg

ABBREVIATIONS

ABBREVIATIONS					
ABV ADJ ALT	ABOVE ADJACENT ALTERNATE	QTY QUAL			
ALN APPRX	ALIGN APPROXIMATE	RAD/r RD			
ARCH	ARCHITECTURAL	REBAR			
ASPH ASTM	ASPHALT AMERICAN SOCIETY FOR TESTING AND	REF REINF			
AOTM	MATERIALS	REM			
BIO	BIO-INFILTRATION	REPL REQD			
BM	BENCH MARK	REV ROW			
BLDG BO	BUILDING BY OTHERS	NOW			
BOT BS	BOTTOM	SCH SD			
ВЗ	BOTH SIDES	SECT			
CAL CB	CALIPER CATCH BASIN	SPEC SQ			
CFCI	CONTRACTOR FURNISHED	SS			
CI	CONTRACTOR INSTALLED CAST IRON	ST STA			
CIPC CJ	CAST-IN-PLACE CONCRETE CONTROL JOINT	STD STL			
CL	CENTERLINE	SYM			
CLR CMU	CLEAR CONCRETE MASONRY UNIT	SHT STRUCT			
CO	CLEAN OUT	S/W			
COL CONC	COLUMN CONCRETE	Т			
CONST CONT	CONSTRUCTION CONTINUOUS	TC TEMP			
CP	COORDINATES POINT / CENTER POINT	THK			
CTR	CENTER	TOC TOS			
DBL DBH	DOUBLE DIAMETER AT BREAST HEIGHT	TOW/TW TYP			
DEMO	DEMOLISH / DEMOLITION				
DET DIA	DETAIL DIAMETER	UNO			
DIM DS	DIMENISION DOWNSPOUT	V (V)			
DWG	DRAWING	VERT VOL			
EA	EACH	XFMR			
EJ ELEC	EXPANSION JOINT ELECTRICAL				
ELEV ENCL	ELEVATION ENCLOSURE	& <			
EOP	EDGE OF PAVEMENT	@ •			
EQUIP EW	EQUIPMENT EACH WAY	ዊ ø			
EXIST	EXISTING	±			
FBO FDC	FURNISHED BY OWNER FIRE DEPARTMENT CONNECTION	#			
FG	FINISH GRADE				
FOC FOW	FACE OF CONCRETE FACE OF WALL				
FS	FINISHED SURFACE				
FTG FURN	FOOTING FURNITURE/ FURNISHED				
GA GALV	GAUGE GALVANIZED				
GC	GENERAL CONTRACTOR				
GND GV	GROUND GATE VALVE				
HOR	HORIZONTAL				
HR	HOUR				
HT/H HVAC	HEIGHT / HIGH HEATING, VENTILATING & AIR CONDITIONING				
ID	INSIDE DIAMETER				
INCL	INCLUDING				
INFO INT	INFORMATION INTERIOR				
MAS	MASONRY				
MAT MAX	MATERIAL MAXIMUM				
MECH	MECHANICAL				
MED MET/MTL	MEDIUM . METAL				
MFR MH	MANUFACTURER MANUFACTURER				
MIN	MANHOLE MINUMUM				
MISC MIX	MISCELLANEOUS MIXTURE				
N	NORTH				
N/A	NOT APPLICABLE				
NIC NO	NOT IN CONTRACT NUMBER				
NOM	NOMINAL				
NTS	NOT TO SCALE				
OC OD	ON CENTER OUTSIDE DIAMETER				
ОН	OVERHEAD				
PA PC	PLANTING AREA PORTLAND CEMENT/PRECAST CONCRETE				
PL	PROPERTY LINE				
POLY PT	POLYETHYLENE PRESSURE TREATED				
PVC	POLYVINYL CHLORIDE				

GENERAL NOTES

QUANTITY

QUALITY

RADIUS

REMOVE

REPLACE

REQUIRED

SCHEDULE

SECTION

SQUARE

STONE

SHEET

STATION

STANDARD STEEL

SYMMETRICAL

STRUCTURAL SIDEWALK

TREAD / THICK

TOP OF CURB

TEMPORARY

THICKNESS

TOP OF WALL

TYPICAL

VERIFY VERTICAL

VOLUME

AND ANGLE AT

TRANSFORMER

CENTERLINE PROPERTY LINE

PLUS OR MINUS

DIAMETER

NUMBER

TOP OF CONCRETE
TOP OF SLAB/ STEEL

VENT / VOLT/ VALVE

UNLESS NOTED OTHERWISE

STORM DRAIN

SPECIFICATION

ROOF DRAIN

REINFORCING BAR

REVISE / REVISION

RIGHT-OF-WAY LINE

REFER OR REFERENCE

REINFORCED / REINFORCING


SANITARY SEWER / STAINLESS STEEL

- SEE SPECIFICATIONS FOR PLANT MATERIAL, TOP SOIL AND PLANTING MIX TYPES AND DEPTH, MULCHING, SOIL AMENDMENTS, FERTILIZERS AND WARRANTIES.
- 2. PLANTING SHALL CONFORM TO ALL CITY OF SEATAC CODE REQUIREMENTS, INCLUDING PRESERVATION OF ADEQUATE INTERSECTION SIGHT DISTANCE LINES/ TRIANGULAR AREAS.
- 3. CONTRACTOR SHALL VERIFY ON-SITE CONDITIONS PRIOR TO BIDDING AND CONSTRUCTION.
- 4. INSTALL AUTOMATIC UNDERGROUND IRRIGATION SYSTEM AS SPECIFIED IN ALL NEW AND RENOVATED LANDSCAPE AREAS.
- 5. THE CONTRACTOR AND OWNER ARE RESPONSIBLE FOR READING THE PLANS, SPECIFICATIONS AND
- 6. THE CONTRACTOR SHALL VERIFY ALL PLANT MATERIAL QUANTITIES PRIOR TO INSTALLATION. ANY PLANT MATERIAL QUANTITIES LISTED ARE FOR THE CONVENIENCE OF THE CONTRACTOR. ACTUAL NUMBER OF SYMBOLS SHALL HAVE PRIORITY OVER QUANTITY DESIGNATED. THE CONTRACTOR SHALL BE RESPONSIBLE FOR COUNTING THE TOTAL NUMBER OF PLANTS INDICATED ON THE PLANS AND ESTIMATING GROUNDCOVER QUANTITIES.
- 7. THE CONTRACTOR SHALL FURNISH AND PAY FOR ALL CONTAINER OR FIELD GROWN TREES, SHRUBS AND GROUNDCOVERS, INCLUDING SEEDED AND SODDED TURF, HYDROMULCHES AND FLATTED GROUNDCOVERS. THE CONTRACTOR SHALL ALSO BE RESPONSIBLE AND PAY FOR: PLANTING OF ALL PLANT MATERIALS; THE SPECIFIED GUARANTEE OF ALL PLANT MATERIALS; THE STAKING AND GUYING OF TREES AND THE CONTINUOUS PROTECTION OF ALL PLANT MATERIALS UPON THEIR ARRIVAL AT THE SITE.

GENERAL SYMBOLS LEGEND

 MATCHLINE
 PROJECT LIMIT / LIMITS OF WORK
 PROPERTY LINE / RIGHT-OF-WAY
 BUILDING SETBACK
 CENTER LINE
 OVERHEAD BUILDING OR CANOPY
EXISTING STRUCTURE
PROPOSED STRUCTURE

GRAPHIC SYMBOLS LEGEND

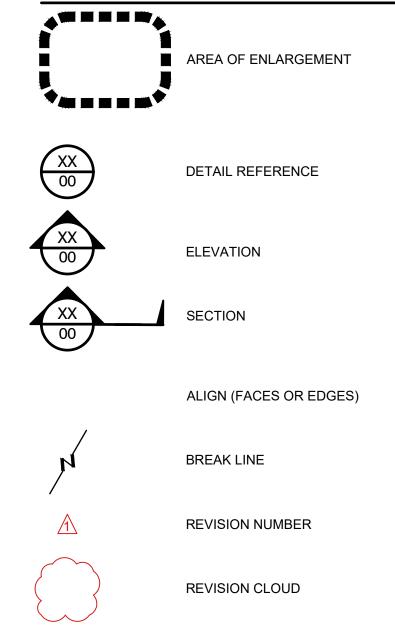

SHEET LIST

Sheet Number	Sheet Title
L0.00	COVER SHEET
L0.01	OVERALL TREE RETENTION PLAN
L0.02	TREE RETENTION PLAN
L0.03	TREE RETENTION PLAN
L0.04	TREE RETENTION PLAN
L0.05	TREE RETENTION PLAN
L0.06	TREE RETENTION PLAN
L0.07	TREE RETENTION PLAN
L1.00	OVERALL LANDSCAPE PLAN
L1.01	LANDSCAPE PLAN
L1.02	LANDSCAPE PLAN
L1.03	LANDSCAPE PLAN
L1.04	LANDSCAPE PLAN
L1.05	LANDSCAPE PLAN
L1.06	LANDSCAPE PLAN
L1.07	PLANTING SCHEDULE
L2.00	SOILS PLAN
L3.00	PLANTING DETAILS
L4.00	PLANTING SPECIFICATIONS





1200 6th Avenue, Suite1620, Seattle, WA 98101 206.267.2425 TEL 206.267.2429 FAX www.ahbl.com WEB

Project Title:

BRIDGE POINT SEATAC 300

Client:

BRIDGE DEVELOPMENT PARTNERS, LLC


10655 NE 4TH STREET, SUITE 500 BELLEVUE, WA 98004 KYLE SIEKAWITCH PH: (425) 749-4325


Project No.

2200531.40

Issue Set & Date:

SITE DEVELOPMENT PERMIT SET

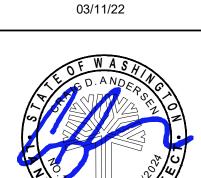

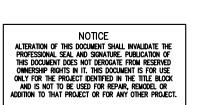

REVISED 06/06/2022 SEPA RESPONSES

REVISED 02/25/2022 SEPA RESPONSES

REVISED 01/21/2022 PER CITY OF SEATAC COMMENTS DATED 01/14/2022

COMMENTS DATED 9/3/2021

REVISED 10/11/2021 PER CITY OF SEATAC

REVISED 7/16/2021 PER CITY OF SEATAC

COMMENTS DATED 5/28/2021

Revisions:

Sheet Title:

COVER SHEET

Designed by:

Drawn by: HS/EH/SW

Sheet No.

L0.00





BRIDGE POINT SEATAC 300

Client:
BRIDGE DEVELOPMENT PARTNERS, LLC

> 10655 NE 4TH STREET, SUITE 500 BELLEVUE, WA 98004 KYLE SIEKAWITCH PH: (425) 749-4325

Project No.


2200531.40

Issue Set & Date:

SITE DEVELOPMENT PERMIT SET

03/11/22



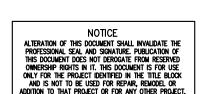

REVISED 06/06/2022 SEPA RESPONSES

REVISED 01/21/2022 PER CITY OF SEATAC COMMENTS DATED 01/14/2022

REVISED 02/25/2022 SEPA RESPONSES

REVISED 10/11/2021 PER CITY OF SEATAC COMMENTS DATED 9/3/2021

REVISED 7/16/2021 PER CITY OF SEATAC COMMENTS DATED 5/28/2021

Sheet Title:

OVERALL TREE RETENTION PLAN

Designed by:

HS/EH/SW

Sheet No.

L0.01 2 of 19heets



*REQUIRED PROPOSED SIGNIFICANT TREES TO NO MORE THAN 410 466 **BE REMOVED** % OF SIGNIFICANT 12% 0% TREES TO BE RETAINED* SIGNIFICANT TREES TO **BE RETAINED** REPLACEMENT TREES 168 169

SIGNIFICANT TREE RETENTION CALCULATIONS 15.445.420

TOTAL SIGNIFICANT TREES: 466

* SMC 15.445.420 12% SIGNIFICANT TREES ON SITE SHALL BE SAVED. TREES LOCATED IN THE FOLLOWING AREAS ARE NOT REQUIRED TO BE SAVED: THE BUILDING FOOTPRINT, WITHIN A PRIVATE ACCESS EASEMENT, INTERIOR ROAD, AND PROPOSED UTILITY EASEMENT. A SIGNIFICANT TREE IS 8"DBH EVERGREEN AND 12"DBH DECIDUOUS (EXCLUDING POPLAR).

LEGEND

TREE TO BE REMOVED TREE TO BE RETAINED OUTSIDE OF PROPERTY LINE. NOT

> PROPERTY LINE RETAINING WALL, SEE CIVIL

INCLUDED IN CALCULATIONS.


TREE NUMBER




SPECIES KEY

A: ALDER C: CEDAR CH: CHERRY CT: COTTONWOOD F: FIR M: MAPLE MA: MADRONA P: PINE U: UNKNOWN U: UNKNOWN DEAD

OAK: OAK

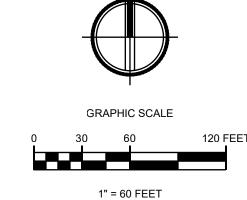



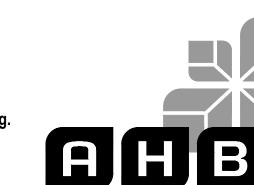

1200 6th Avenue, Suite1620,Seattle, WA 98101 206.267.2425 TEL 206.267.2429 FAX www.ahbl.com WEB

Project Title:

BRIDGE POINT SEATAC 300

BRIDGE DEVELOPMENT PARTNERS, LLC

10655 NE 4TH STREET, SUITE 500 BELLEVUE, WA 98004 KYLE SIEKAWITCH PH: (425) 749-4325

Project No.


2200531.40

Issue Set & Date:

SITE DEVELOPMENT PERMIT SET

03/11/22



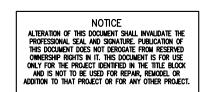

REVISED 06/06/2022 SEPA RESPONSES

REVISED 02/25/2022 SEPA RESPONSES

REVISED 01/21/2022 PER CITY OF SEATAC COMMENTS DATED 01/14/2022

REVISED 10/11/2021 PER CITY OF SEATAC COMMENTS DATED 9/3/2021

REVISED 7/16/2021 PER CITY OF SEATAC COMMENTS DATED 5/28/2021

Sheet Title:

TREE RETENTION PLAN


Designed by:

GRAPHIC SCALE

1" = 20 FEET

HS/EH/SW

L0.02 3 of **19**heets

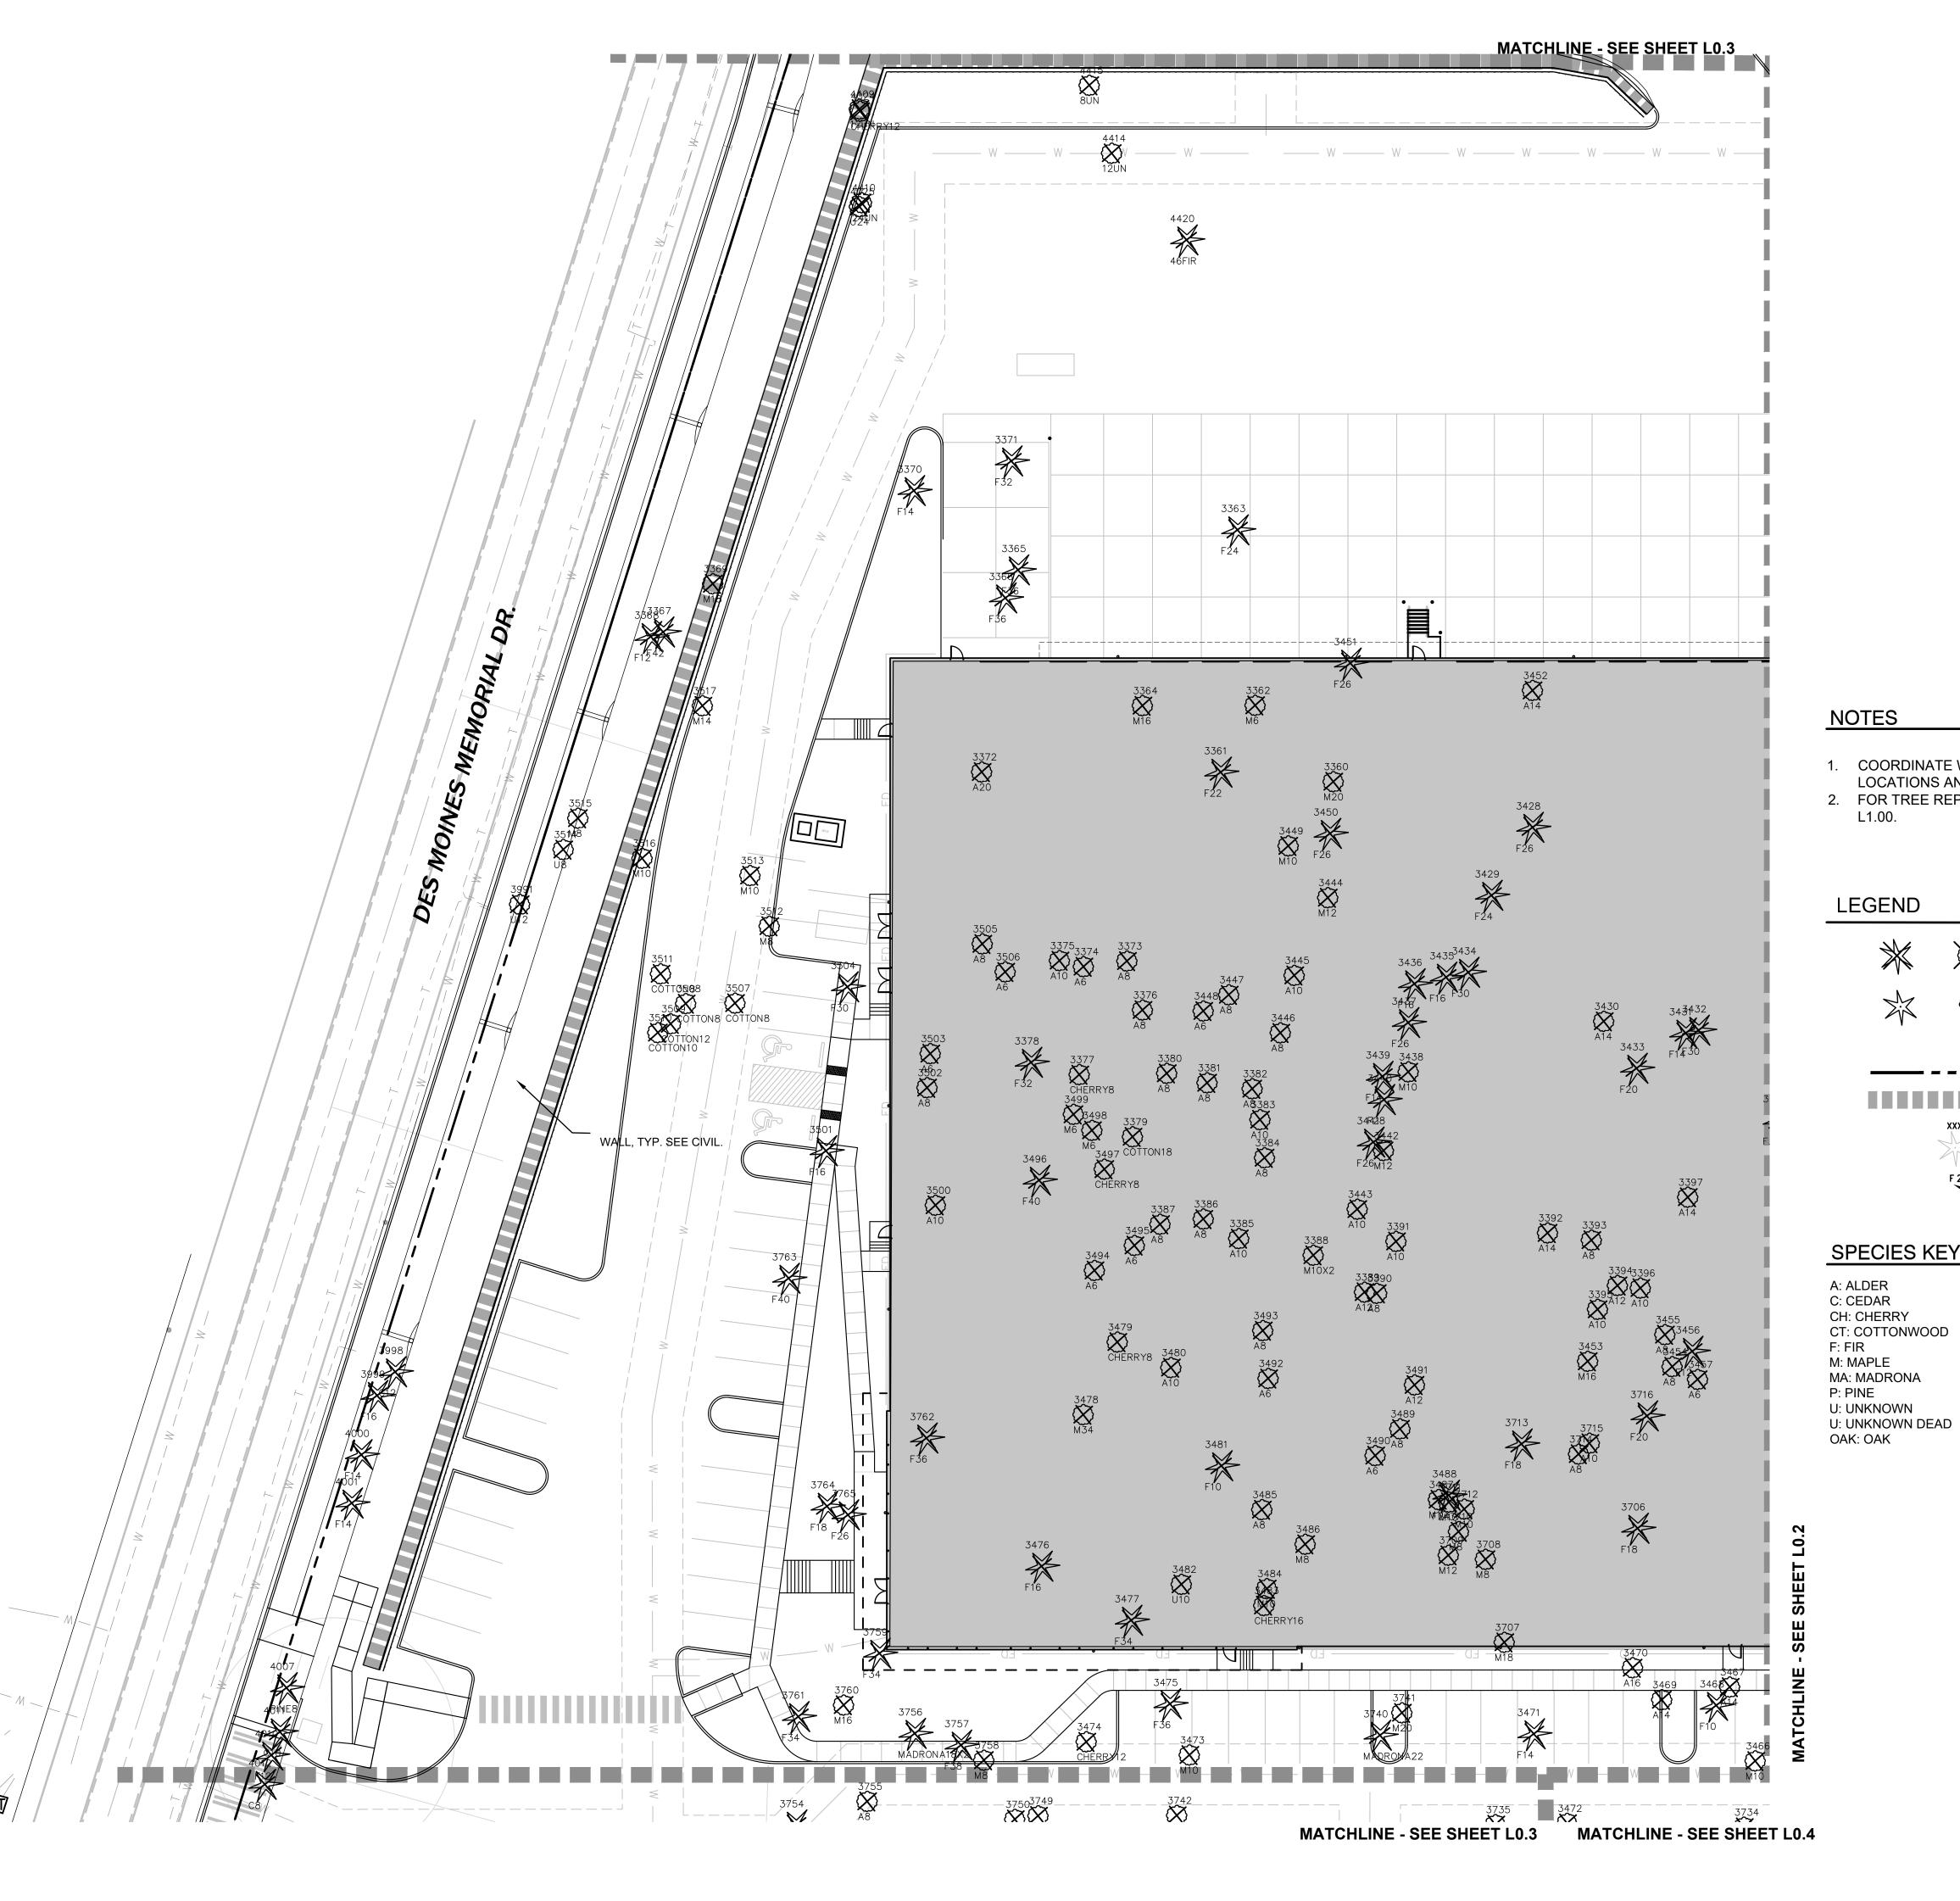

NOTES

- 1. COORDINATE WITH CIVIL FOR TREE PROTECTION
- LOCATIONS AND CLEARING LIMITS. 2. FOR TREE REPLACEMENT LOCATIONS SEE SHEET

LEGEND








TREE TO BE RETAINED OUTSIDE OF PROPERTY LINE. NOT INCLUDED IN CALCULATIONS.

PROPERTY LINE WALL- SEE CIVIL

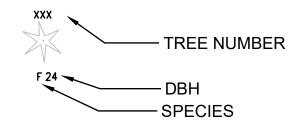

SPECIES KEY

A: ALDER C: CEDAR CH: CHERRY CT: COTTONWOOD

MA: MADRONA





1200 6th Avenue, Suite1620,Seattle, WA 98101 206.267.2425 TEL 206.267.2429 FAX www.ahbl.com WEB

Project Title:

BRIDGE POINT SEATAC 300

BRIDGE DEVELOPMENT PARTNERS, LLC

10655 NE 4TH STREET, SUITE 500 BELLEVUE, WA 98004 KYLE SIEKAWITCH PH: (425) 749-4325

Project No.


2200531.40

Issue Set & Date:

SITE DEVELOPMENT **PERMIT SET**

03/11/22



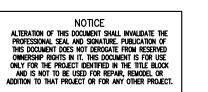

TREE TO BE REMOVED

PROPERTY LINE

WALL- SEE CIVIL

TREE NUMBER

-SPECIES

TREE TO BE RETAINED OUTSIDE OF PROPERTY LINE. NOT INCLUDED IN CALCULATIONS.

REVISED 06/06/2022 SEPA RESPONSES REVISED 02/25/2022 SEPA RESPONSES

> REVISED 01/21/2022 PER CITY OF SEATAC COMMENTS DATED 01/14/2022

REVISED 10/11/2021 PER CITY OF SEATAC COMMENTS DATED 9/3/2021

REVISED 7/16/2021 PER CITY OF SEATAC COMMENTS DATED 5/28/2021

Sheet Title:


TREE RETENTION PLAN

Designed by:

HS/EH/SW

Sheet No.

L0.03 4 of 19heets

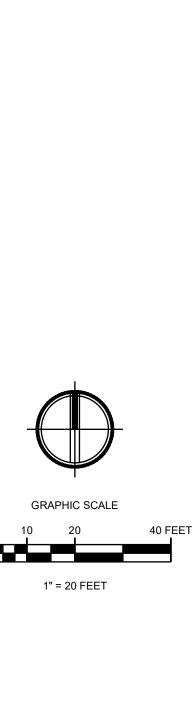





1200 6th Avenue, Suite1620, Seattle, WA 98101 206.267.2425 TEL 206.267.2429 FAX www.ahbl.com WEB

Project Title:

BRIDGE POINT SEATAC 300

Client:
BRIDGE DEVELOPMENT PARTNERS, LLC

> 10655 NE 4TH STREET, SUITE 500 BELLEVUE, WA 98004 KYLE SIEKAWITCH PH: (425) 749-4325

Project No.


2200531.40

Issue Set & Date:

SITE DEVELOPMENT PERMIT SET

03/11/22



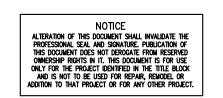

REVISED 06/06/2022 SEPA RESPONSES

REVISED 02/25/2022 SEPA RESPONSES

REVISED 01/21/2022 PER CITY OF SEATAC COMMENTS DATED 01/14/2022

REVISED 10/11/2021 PER CITY OF SEATAC COMMENTS DATED 9/3/2021

REVISED 7/16/2021 PER CITY OF SEATAC COMMENTS DATED 5/28/2021

Sheet Title:


Sheet No.


TREE RETENTION PLAN

Designed by:

HS/EH/SW

L0.04 5 of 1**S**heets

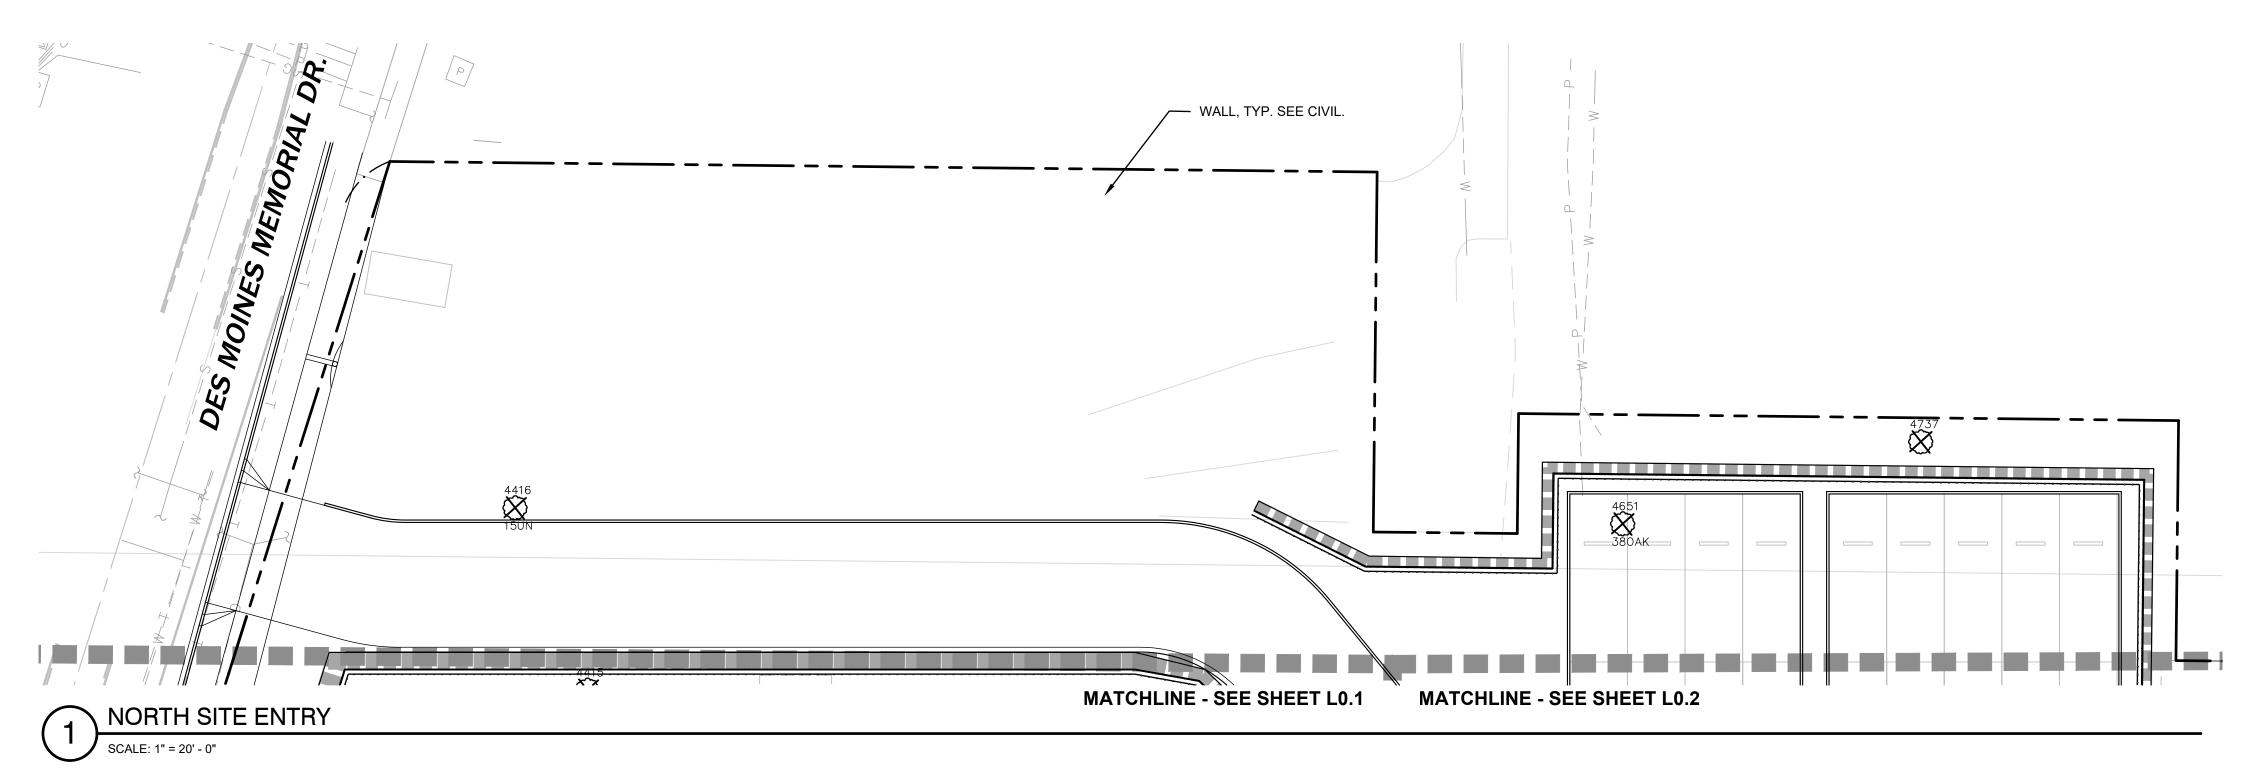

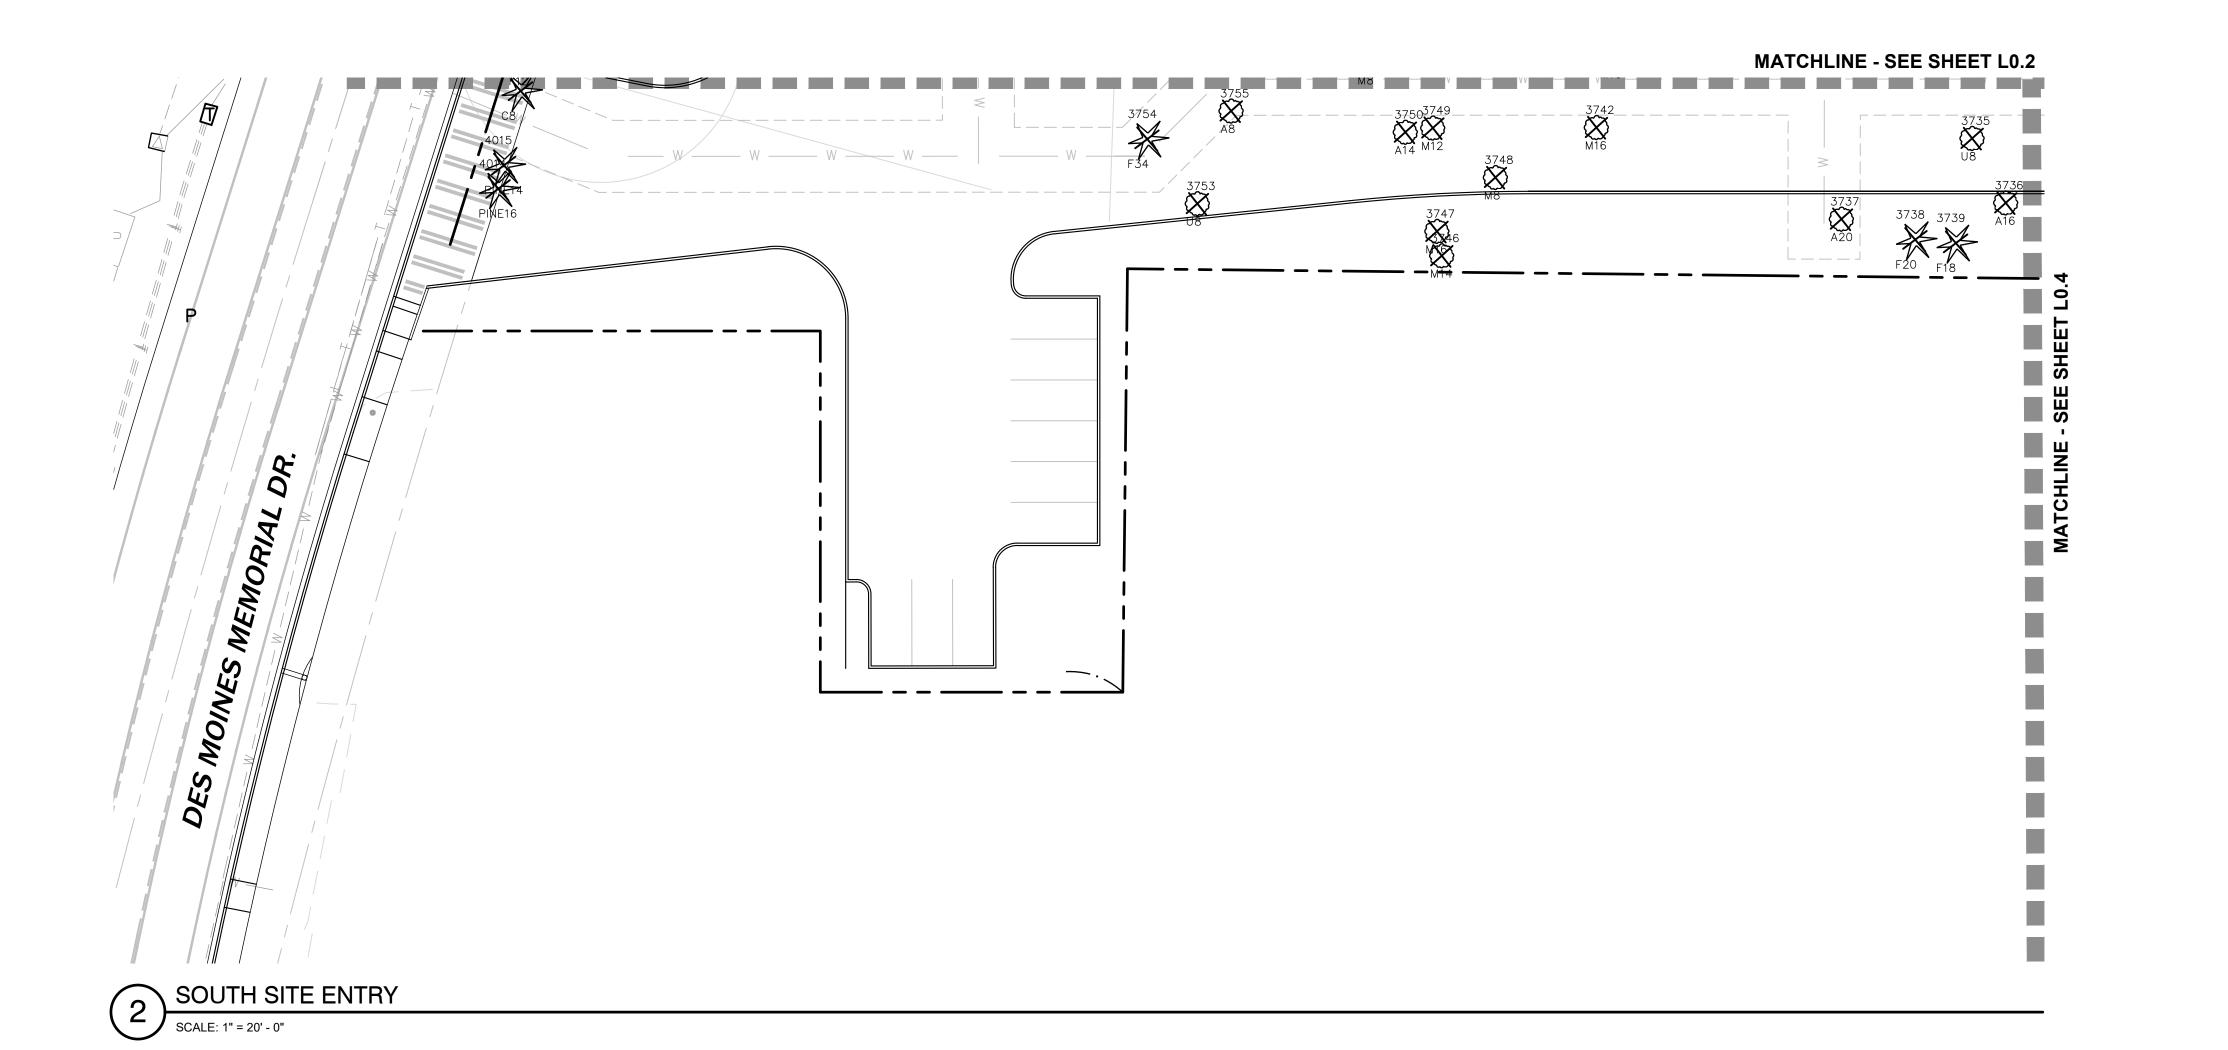

NOTES


- COORDINATE WITH CIVIL FOR TREE PROTECTION LOCATIONS AND CLEARING LIMITS.
- 2. FOR TREE REPLACEMENT LOCATIONS SEE SHEET L1.00.

LEGEND

TREE TO BE REMOVED

TREE TO BE RETAINED OUTSIDE OF PROPERTY LINE. NOT INCLUDED IN CALCULATIONS.

PROPERTY LINE WALL- SEE CIVIL

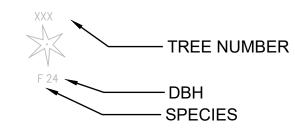


SPECIES KEY

- A: ALDER C: CEDAR
- CH: CHERRY
- CT: COTTONWOOD F: FIR
- M: MAPLE MA: MADRONA

OAK: OAK

- P: PINE U: UNKNOWN U: UNKNOWN DEAD

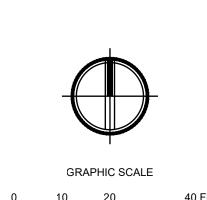

1" = 20 FEET

MATCHLINE - SEE SHEET L0.6





1200 6th Avenue, Suite1620, Seattle, WA 98101 206.267.2425 TEL 206.267.2429 FAX www.ahbl.com WEB

Project Title:

BRIDGE POINT SEATAC 300

BRIDGE DEVELOPMENT PARTNERS, LLC

> 10655 NE 4TH STREET, SUITE 500 BELLEVUE, WA 98004 KYLE SIEKAWITCH PH: (425) 749-4325

Project No.


2200531.40

Issue Set & Date:

SITE DEVELOPMENT PERMIT SET

03/11/22



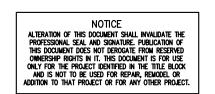

LOCATIONS AND CLEARING LIMITS.

TREE TO BE REMOVED

PROPERTY LINE

WALL- SEE CIVIL

TREE NUMBER

- SPECIES

TREE TO BE RETAINED OUTSIDE

INCLUDED IN CALCULATIONS.

A: ALDER C: CEDAR

LEGEND

CH: CHERRY CT: COTTONWOOD

F: FIR M: MAPLE MA: MADRONA

P: PINE U: UNKNOWN REVISED 06/06/2022 SEPA RESPONSES

REVISED 02/25/2022 SEPA RESPONSES


REVISED 01/21/2022 PER CITY OF SEATAC COMMENTS DATED 01/14/2022

REVISED 10/11/2021 PER CITY OF SEATAC COMMENTS DATED 9/3/2021

REVISED 7/16/2021 PER CITY OF SEATAC COMMENTS DATED 5/28/2021

Sheet Title:

TREE RETENTION PLAN

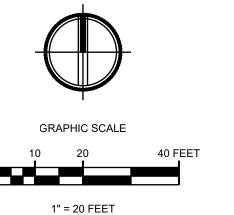

Designed by:

HS/EH/SW

Sheet No.

L0.05 6 of 1**S**heets



TREE TO BE REMOVED

PROPERTY LINE

WALL- SEE CIVIL

TREE NUMBER

TREE TO BE RETAINED OUTSIDE

GRAPHIC SCALE

1" = 20 FEET

OF PROPERTY LINE. NOT INCLUDED IN CALCULATIONS.



1200 6th Avenue, Suite1620, Seattle, WA 98101 206.267.2425 TEL 206.267.2429 FAX www.ahbl.com WEB

Project Title:

BRIDGE POINT SEATAC 300

BRIDGE DEVELOPMENT PARTNERS, LLC

10655 NE 4TH STREET, SUITE 500 BELLEVUE, WA 98004 KYLE SIEKAWITCH PH: (425) 749-4325

Project No.


2200531.40

Issue Set & Date:

SITE DEVELOPMENT PERMIT SET

03/11/22



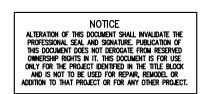

REVISED 06/06/2022 SEPA RESPONSES

REVISED 02/25/2022 SEPA RESPONSES

REVISED 01/21/2022 PER CITY OF SEATAC COMMENTS DATED 01/14/2022

REVISED 10/11/2021 PER CITY OF SEATAC COMMENTS DATED 9/3/2021

REVISED 7/16/2021 PER CITY OF SEATAC COMMENTS DATED 5/28/2021


Sheet Title:

TREE RETENTION PLAN

Designed by:

HS/EH/SW

L0.06 7 of 19heets

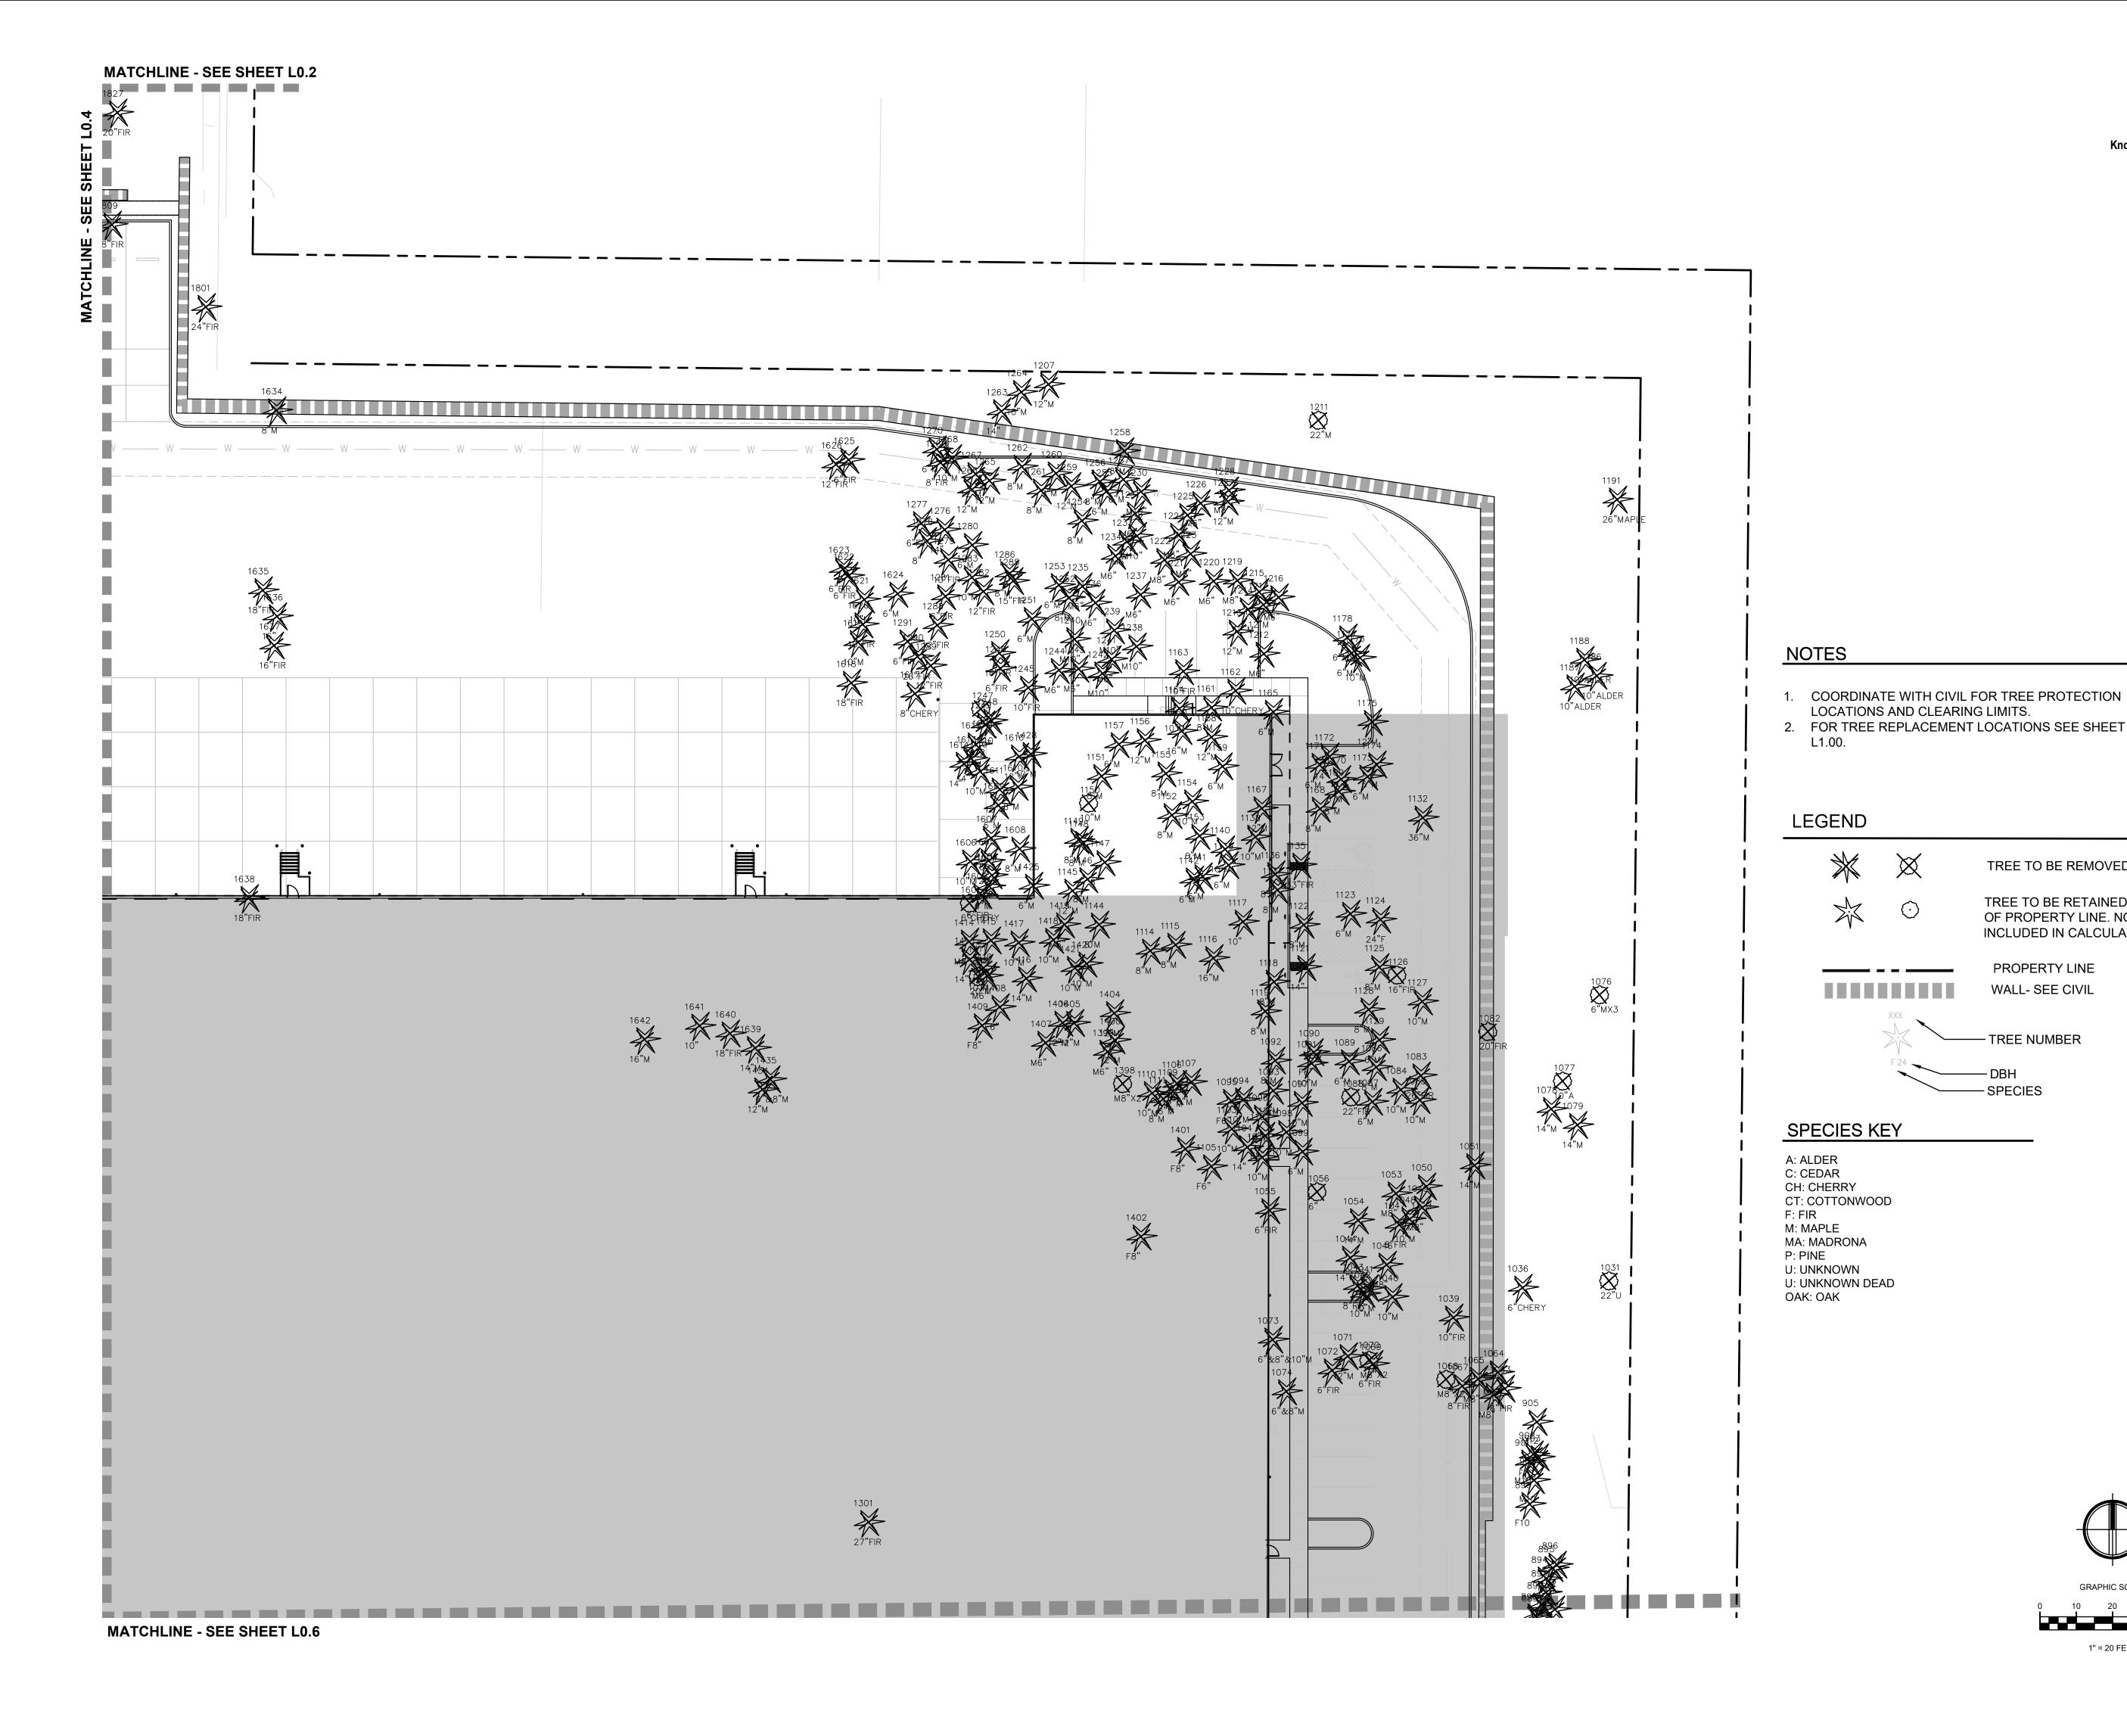





1200 6th Avenue, Suite1620, Seattle, WA 98101 206.267.2425 TEL 206.267.2429 FAX www.ahbl.com WEB

Project Title:

BRIDGE POINT SEATAC 300

BRIDGE DEVELOPMENT PARTNERS, LLC

10655 NE 4TH STREET, SUITE 500 BELLEVUE, WA 98004 KYLE SIEKAWITCH PH: (425) 749-4325

Project No.

2200531.40

Issue Set & Date:

SITE DEVELOPMENT PERMIT SET





REVISED 06/06/2022 SEPA RESPONSES

REVISED 02/25/2022 SEPA RESPONSES REVISED 01/21/2022 PER CITY OF SEATAC COMMENTS DATED 01/14/2022

REVISED 10/11/2021 PER CITY OF SEATAC COMMENTS DATED 9/3/2021

REVISED 7/16/2021 PER CITY OF SEATAC COMMENTS DATED 5/28/2021


Sheet Title:

TREE RETENTION PLAN

Designed by:


HS/EH/SW

L0.07 8 of 19heets

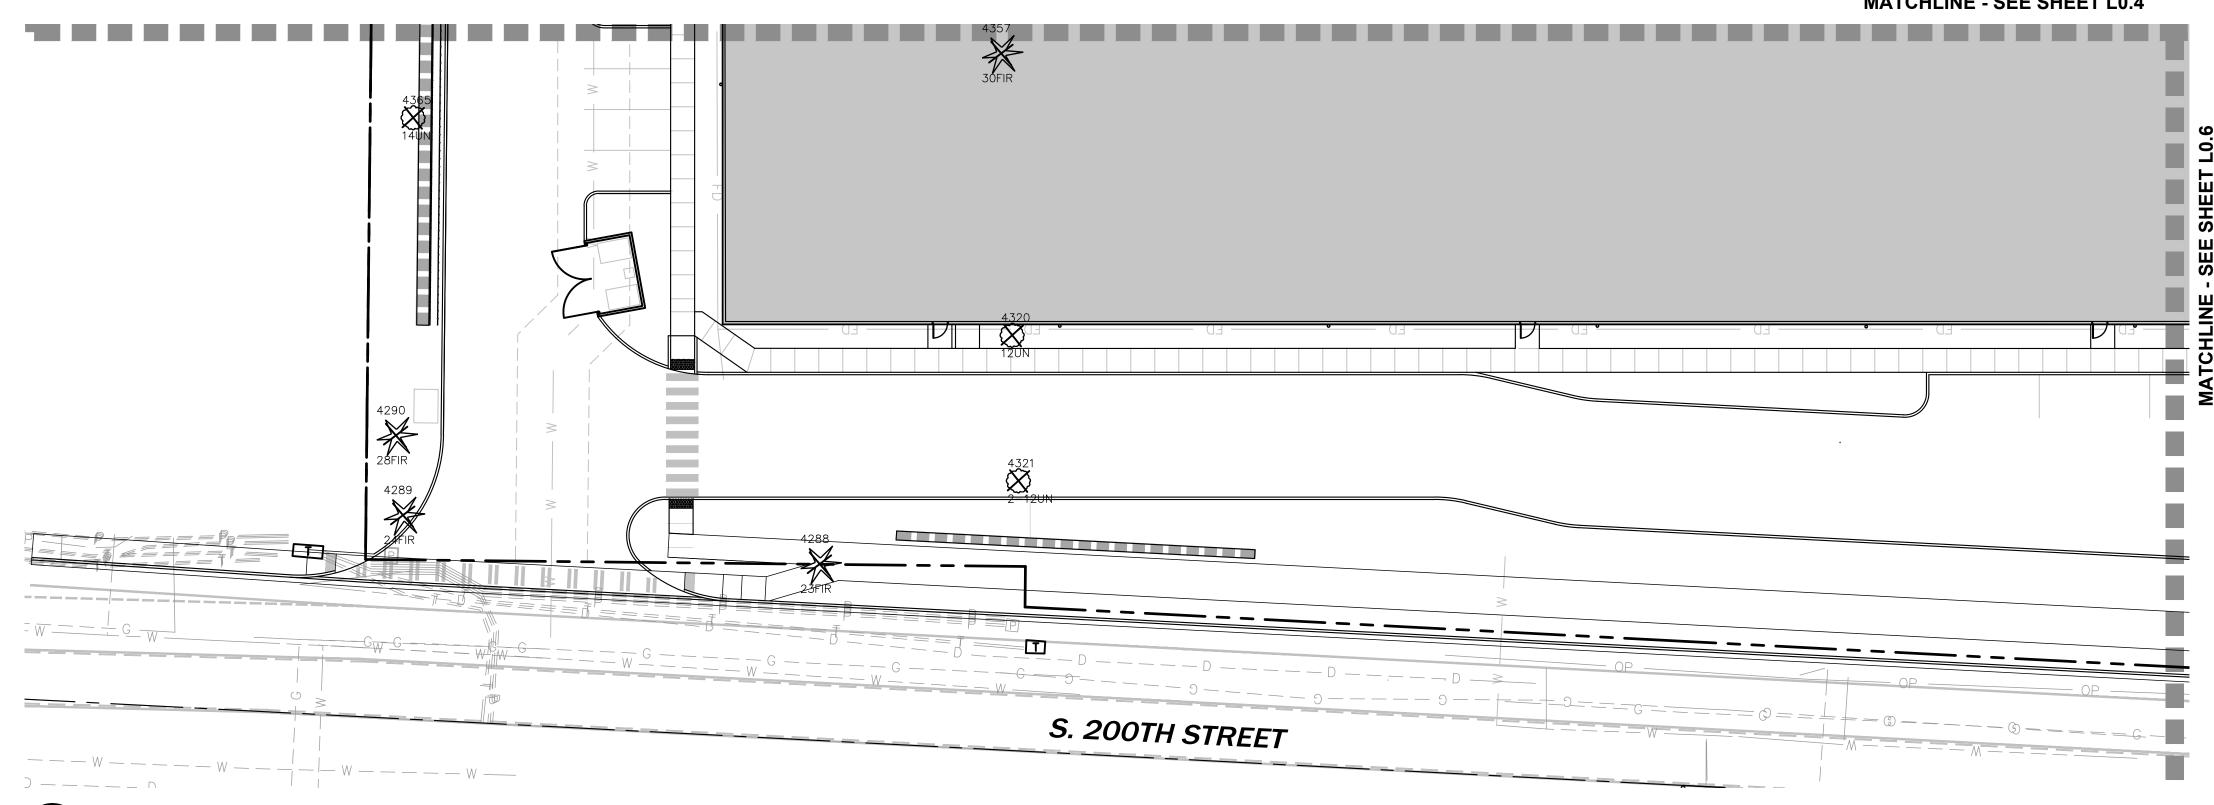

↑ SOUTH 200TH STREET WEST ENTRY


SCALE: 1" = 20' - 0"

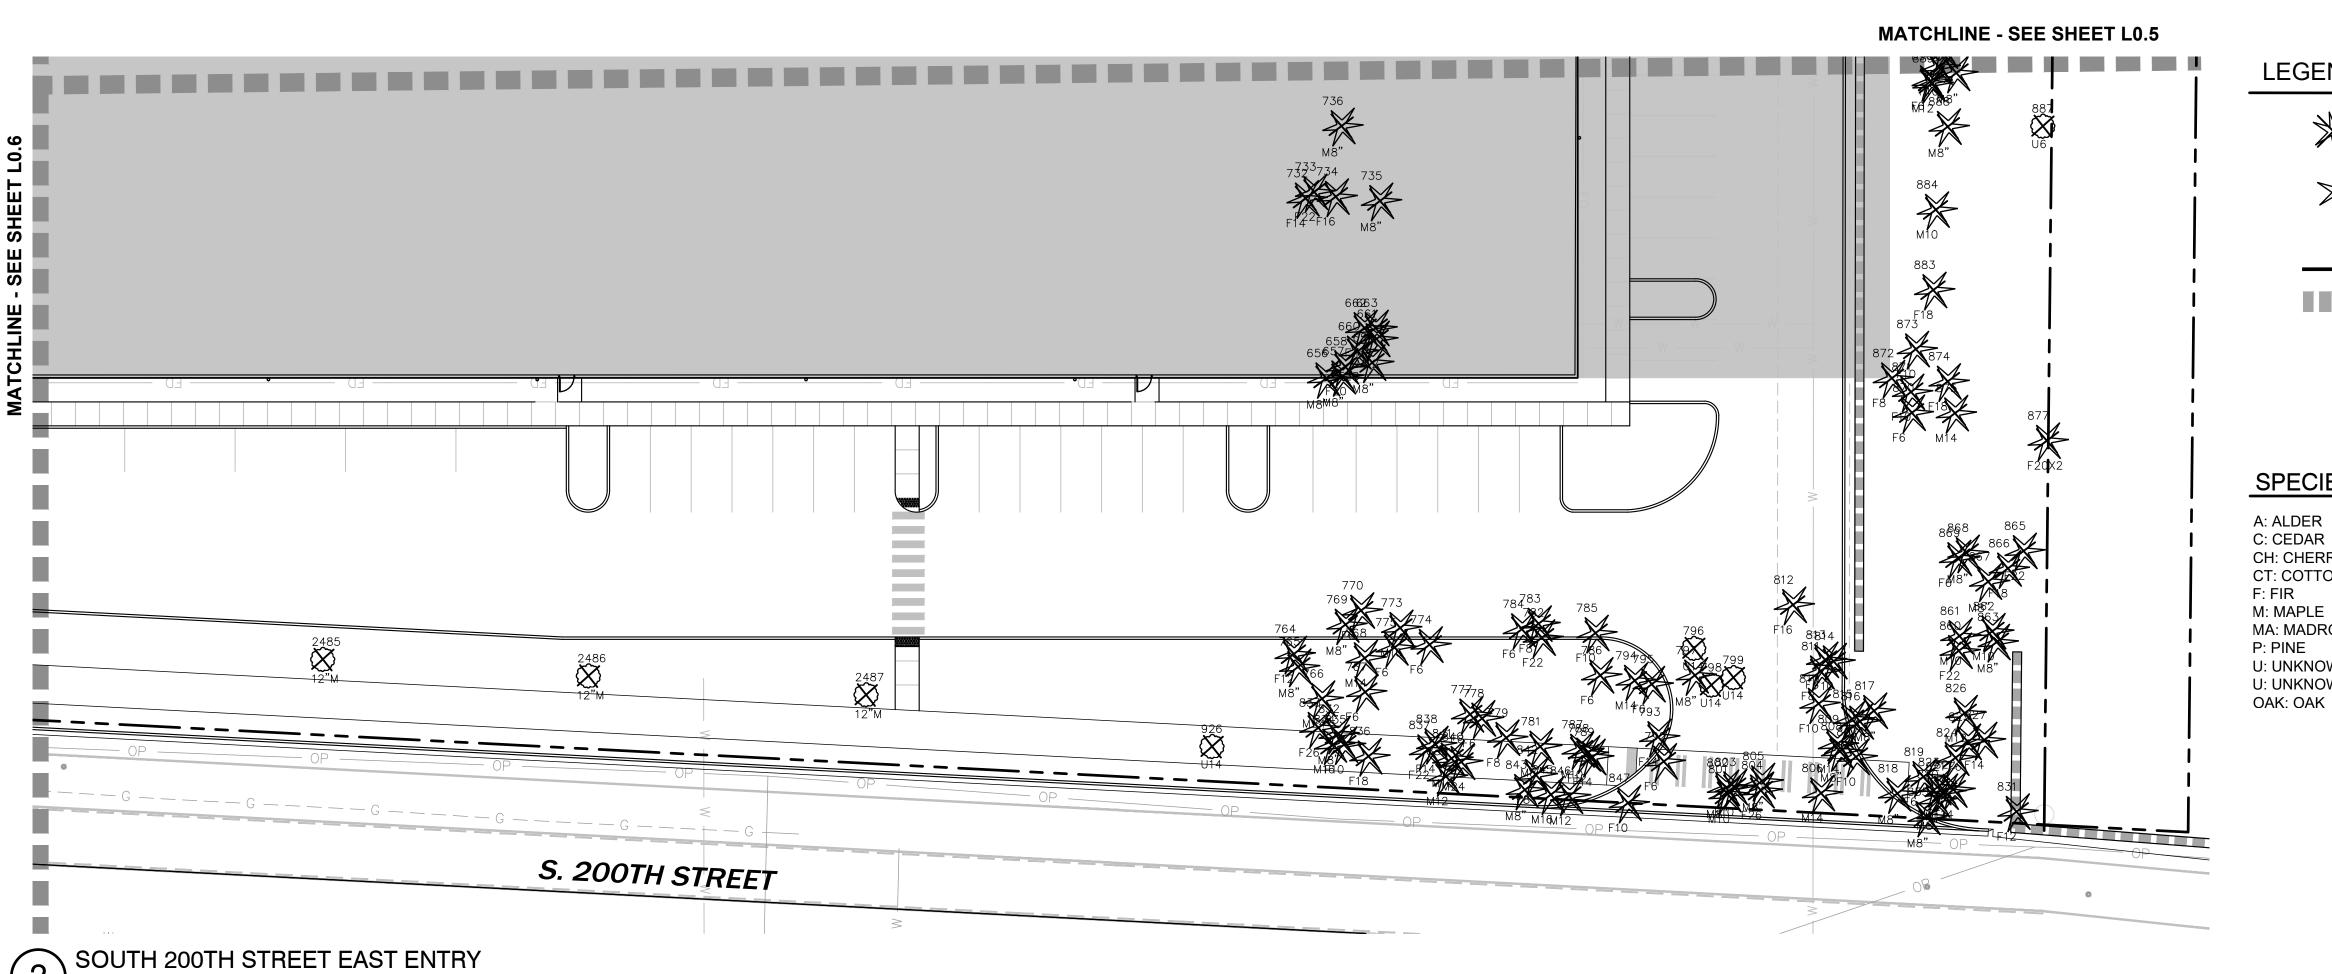

NOTES

- 1. COORDINATE WITH CIVIL FOR TREE PROTECTION
- LOCATIONS AND CLEARING LIMITS. 2. FOR TREE REPLACEMENT LOCATIONS SEE SHEET
- L1.00.

LEGEND

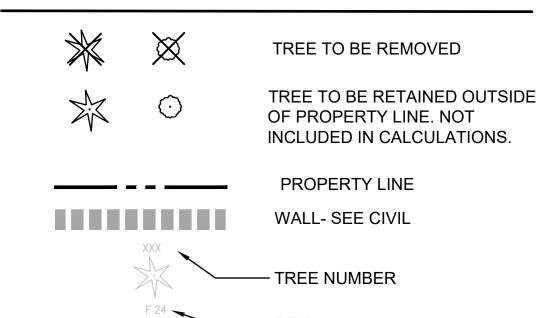


- SPECIES

SPECIES KEY

A: ALDER C: CEDAR CH: CHERRY CT: COTTONWOOD F: FIR M: MAPLE MA: MADRONA P: PINE U: UNKNOWN U: UNKNOWN DEAD

> GRAPHIC SCALE 1" = 20 FEET

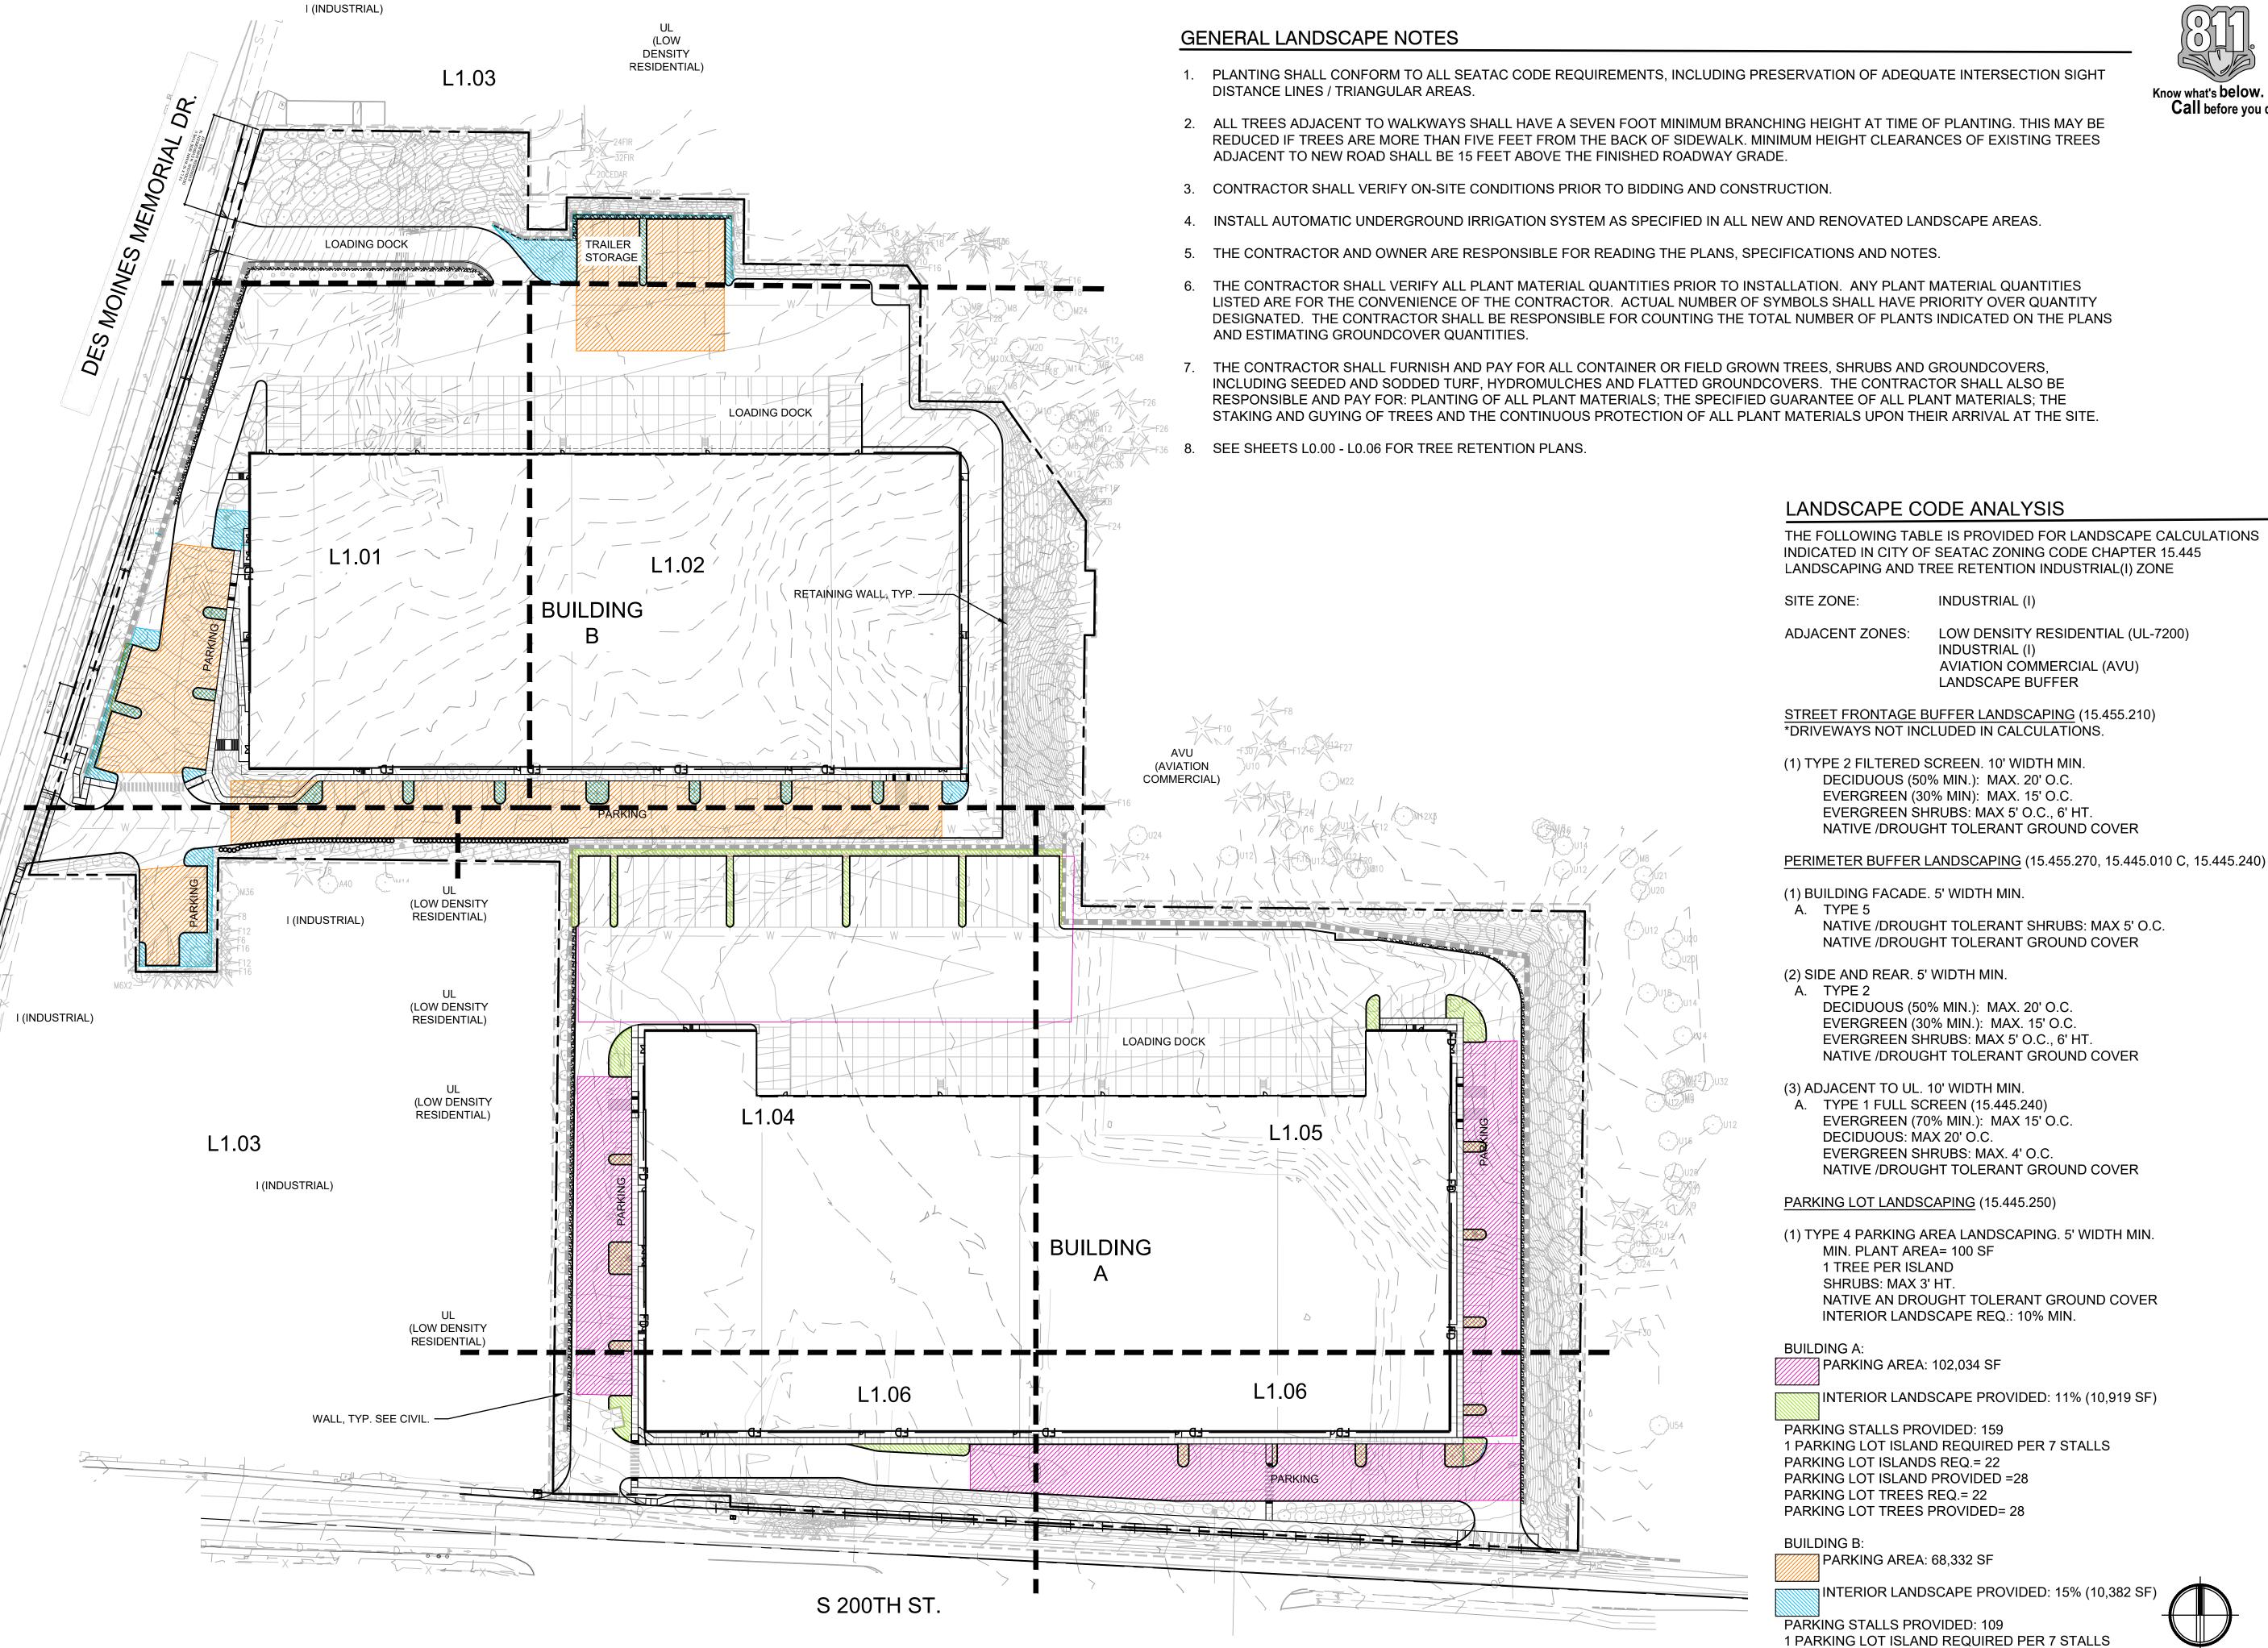

1. PLANTING SHALL CONFORM TO ALL SEATAC CODE REQUIREMENTS, INCLUDING PRESERVATION OF ADEQUATE INTERSECTION SIGHT



INDUSTRIAL (I)

INDUSTRIAL (I)

DECIDUOUS (50% MIN.): MAX. 20' O.C. EVERGREEN (30% MIN): MAX. 15' O.C. EVERGREEN SHRUBS: MAX 5' O.C., 6' HT.

A. TYPE 2

NATIVE /DROUGHT TOLERANT GROUND COVER

NATIVE /DROUGHT TOLERANT SHRUBS: MAX 5' O.C.

NATIVE /DROUGHT TOLERANT GROUND COVER

NATIVE /DROUGHT TOLERANT GROUND COVER

NATIVE /DROUGHT TOLERANT GROUND COVER

NATIVE AN DROUGHT TOLERANT GROUND COVER

INTERIOR LANDSCAPE PROVIDED: 11% (10,919 SF)

INTERIOR LANDSCAPE PROVIDED: 15% (10,382 SF)

DECIDUOUS (50% MIN.): MAX. 20' O.C.

EVERGREEN (30% MIN.): MAX. 15' O.C. EVERGREEN SHRUBS: MAX 5' O.C., 6' HT.

EVERGREEN (70% MIN.): MAX 15' O.C.

INTERIOR LANDSCAPE REQ.: 10% MIN.

EVERGREEN SHRUBS: MAX. 4' O.C.

A. TYPE 1 FULL SCREEN (15.445.240)

DECIDUOUS: MAX 20' O.C.

MIN. PLANT AREA= 100 SF

PARKING AREA: 102,034 SF

PARKING AREA: 68,332 SF

PARKING LOT ISLANDS REQ.= 16

PARKING LOT TREES REQ.= 16

PARKING LOT ISLAND PROVIDED = 24

PARKING LOT TREES PROVIDED= 25

1 TREE PER ISLAND SHRUBS: MAX 3' HT.

LANDSCAPE BUFFER

LOW DENSITY RESIDENTIAL (UL-7200)

AVIATION COMMERCIAL (AVU)

1200 6th Avenue, Suite1620, Seattle, WA 98101 206.267.2425 TEL 206.267.2429 FAX www.ahbl.com WEB

BRIDGE POINT SEATAC 300

Project Title:

BRIDGE DEVELOPMENT PARTNERS, LLC


> 10655 NE 4TH STREET, SUITE 500 BELLEVUE, WA 98004 KYLE SIEKAWITCH PH: (425) 749-4325

2200531.40

Issue Set & Date:

SITE DEVELOPMENT PERMIT SET

03/11/22

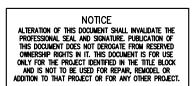

REVISED 06/06/2022 SEPA RESPONSES

REVISED 02/25/2022 SEPA RESPONSES

COMMENTS DATED 5/28/2021

Sheet Title:

OVERALL LANDSCAPE PLAN

HS/EH/SW


Sheet No.

9 of 1**9**heets

1" = 60 FEET

THE FOLLOWING TABLE IS PROVIDED FOR LANDSCAPE CALCULATIONS Project No.



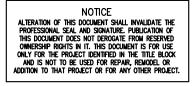


REVISED 01/21/2022 PER CITY OF SEATAC COMMENTS DATED 01/14/2022

REVISED 10/11/2021 PER CITY OF SEATAC COMMENTS DATED 9/3/2021

REVISED 7/16/2021 PER CITY OF SEATAC

Designed by: MS

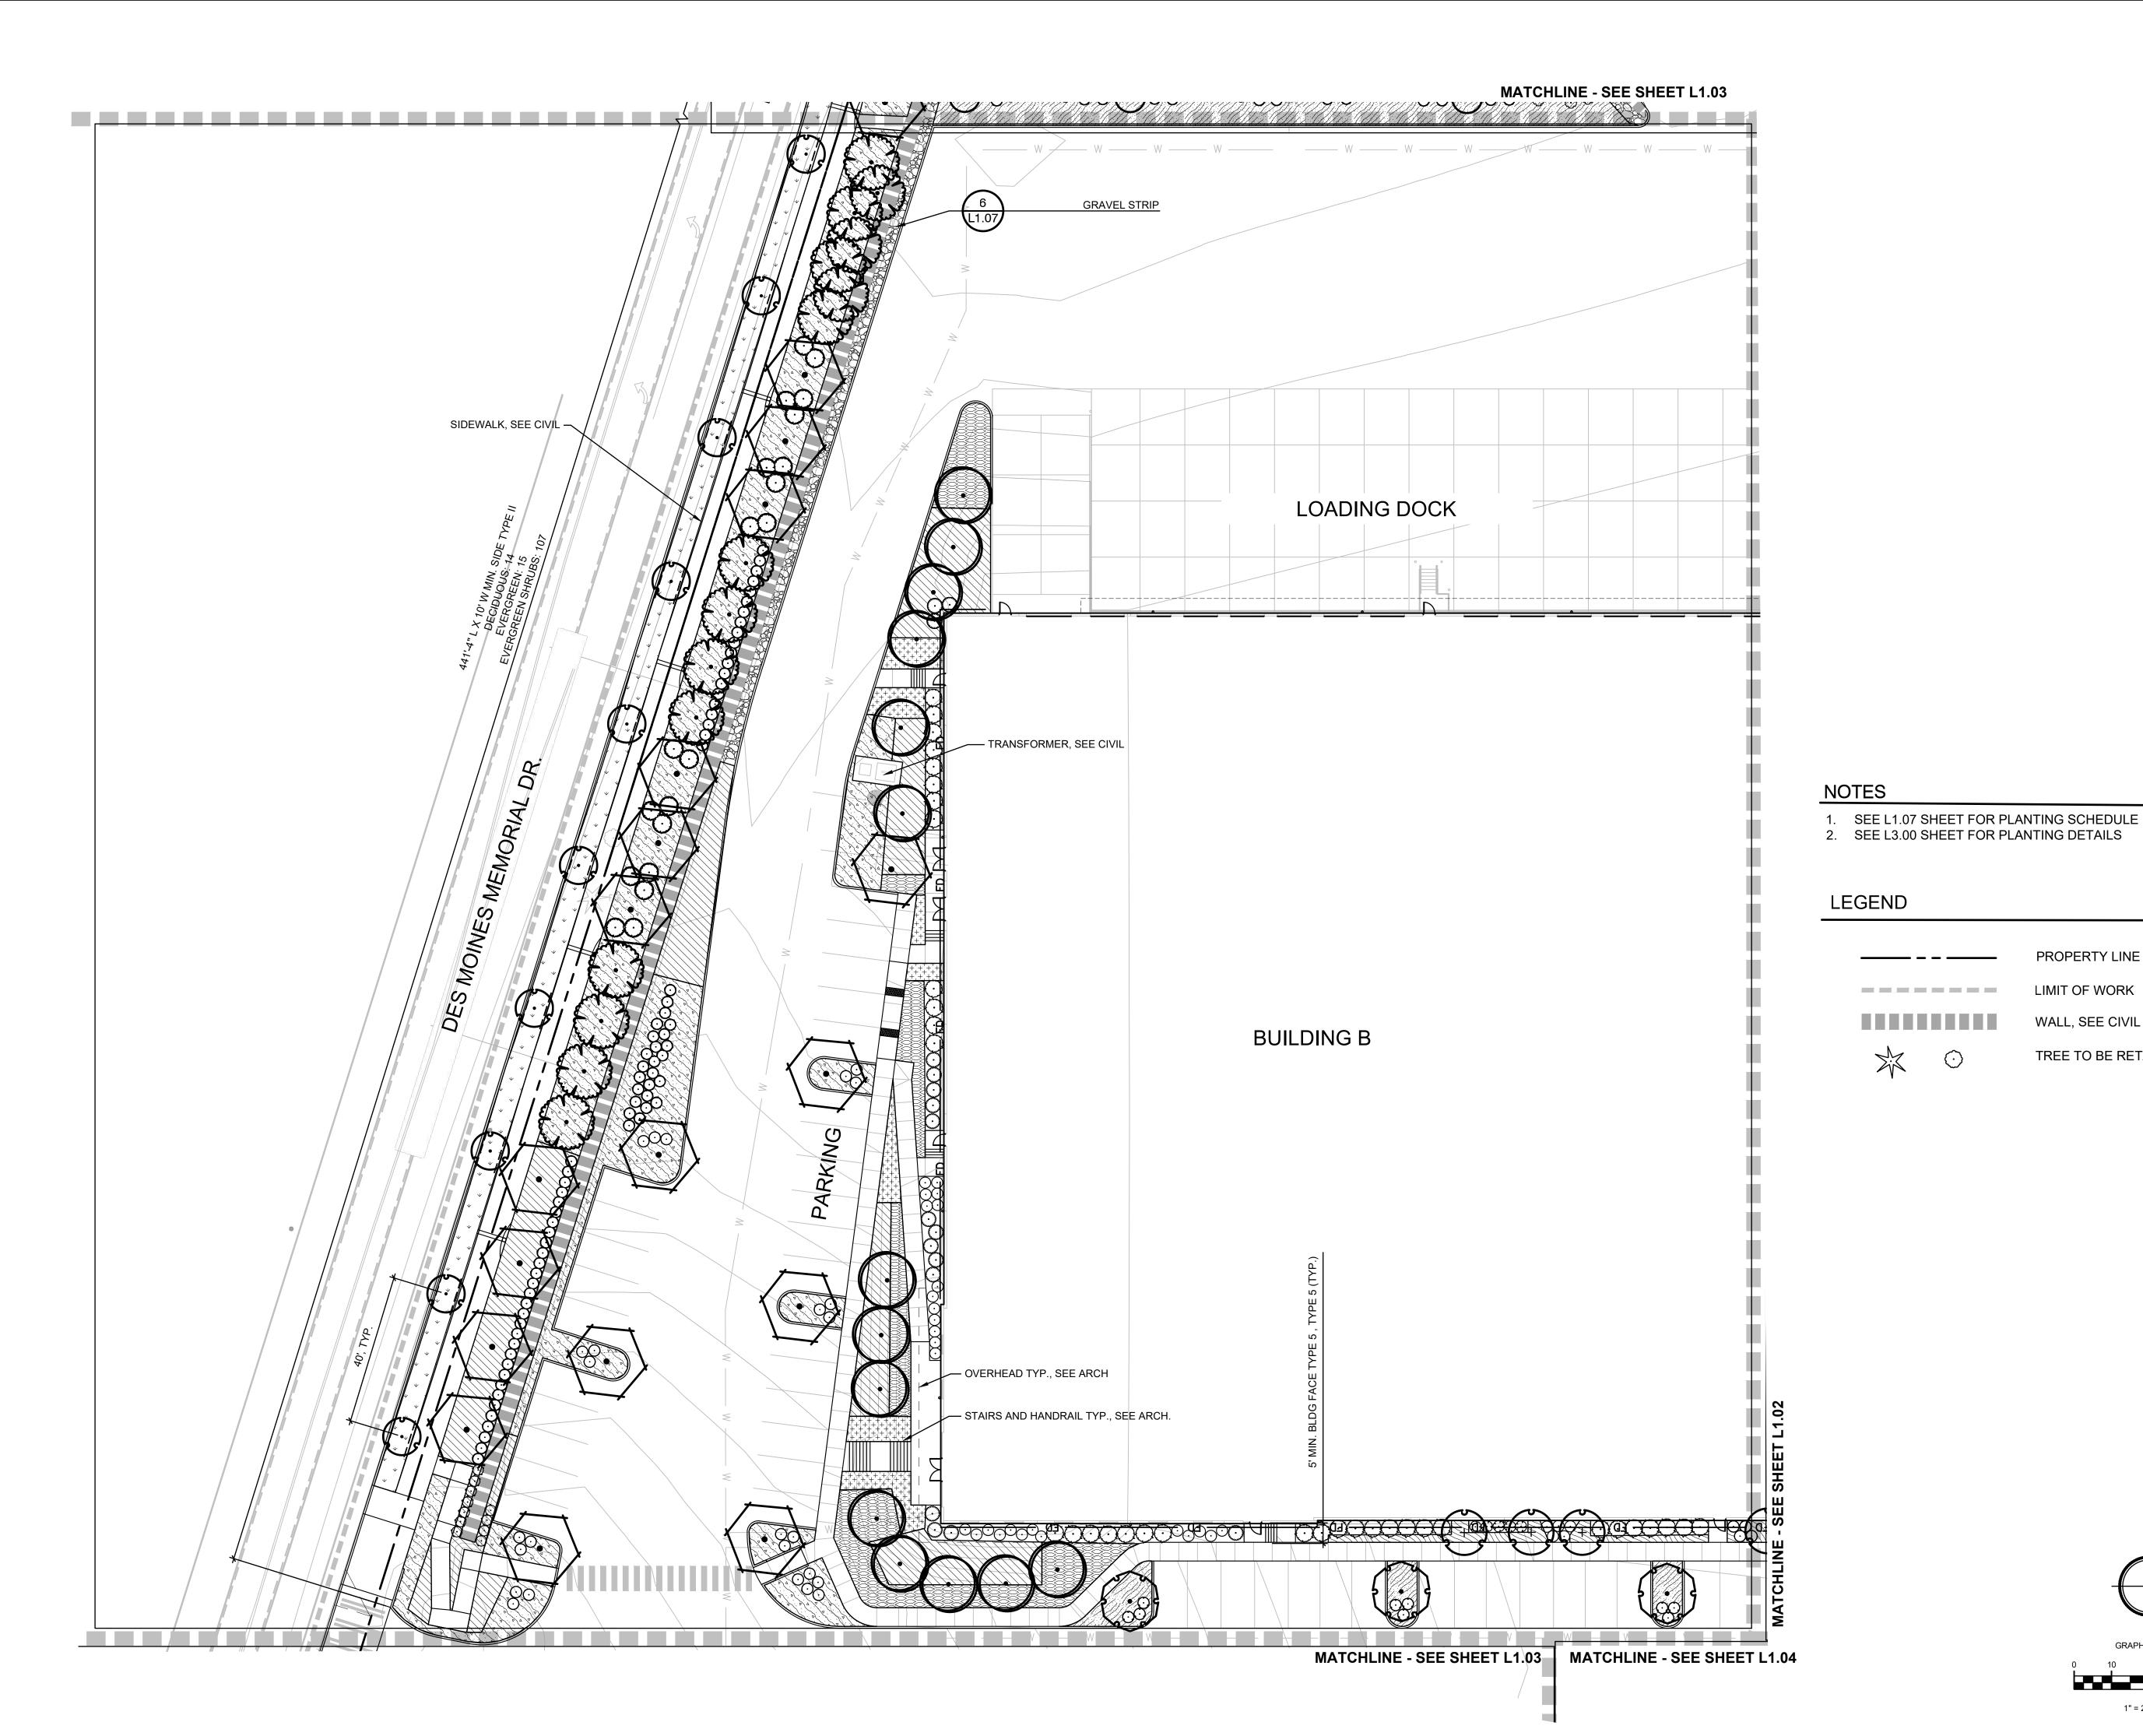





BRIDGE POINT SEATAC 300

BRIDGE DEVELOPMENT PARTNERS, LLC

10655 NE 4TH STREET, SUITE 500 BELLEVUE, WA 98004 KYLE SIEKAWITCH PH: (425) 749-4325

Project No.


2200531.40

Issue Set & Date:

SITE DEVELOPMENT PERMIT SET

03/11/22



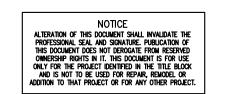

REVISED 06/06/2022 SEPA RESPONSES

REVISED 02/25/2022 SEPA RESPONSES

REVISED 01/21/2022 PER CITY OF SEATAC COMMENTS DATED 01/14/2022

REVISED 10/11/2021 PER CITY OF SEATAC COMMENTS DATED 9/3/2021

REVISED 7/16/2021 PER CITY OF SEATAC COMMENTS DATED 5/28/2021

Sheet Title:

PLANTING PLAN

1" = 20 FEET

PROPERTY LINE

LIMIT OF WORK

WALL, SEE CIVIL

TREE TO BE RETAINED

HS/EH/SW





1200 6th Avenue, Suite1620,Seattle, WA 98101 206.267.2425 TEL 206.267.2429 FAX www.ahbl.com WEB

Project Title:

BRIDGE POINT SEATAC 300

BRIDGE DEVELOPMENT PARTNERS, LLC

10655 NE 4TH STREET, SUITE 500 BELLEVUE, WA 98004 KYLE SIEKAWITCH PH: (425) 749-4325

Project No.


2200531.40

Issue Set & Date:

SITE DEVELOPMENT PERMIT SET

03/11/22



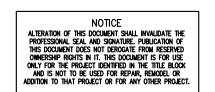

REVISED 06/06/2022 SEPA RESPONSES

REVISED 02/25/2022 SEPA RESPONSES

REVISED 01/21/2022 PER CITY OF SEATAC COMMENTS DATED 01/14/2022

REVISED 10/11/2021 PER CITY OF SEATAC COMMENTS DATED 9/3/2021


REVISED 7/16/2021 PER CITY OF SEATAC COMMENTS DATED 5/28/2021

Sheet Title:

PLANTING PLAN

HS/EH/SW

1" = 20 FEET

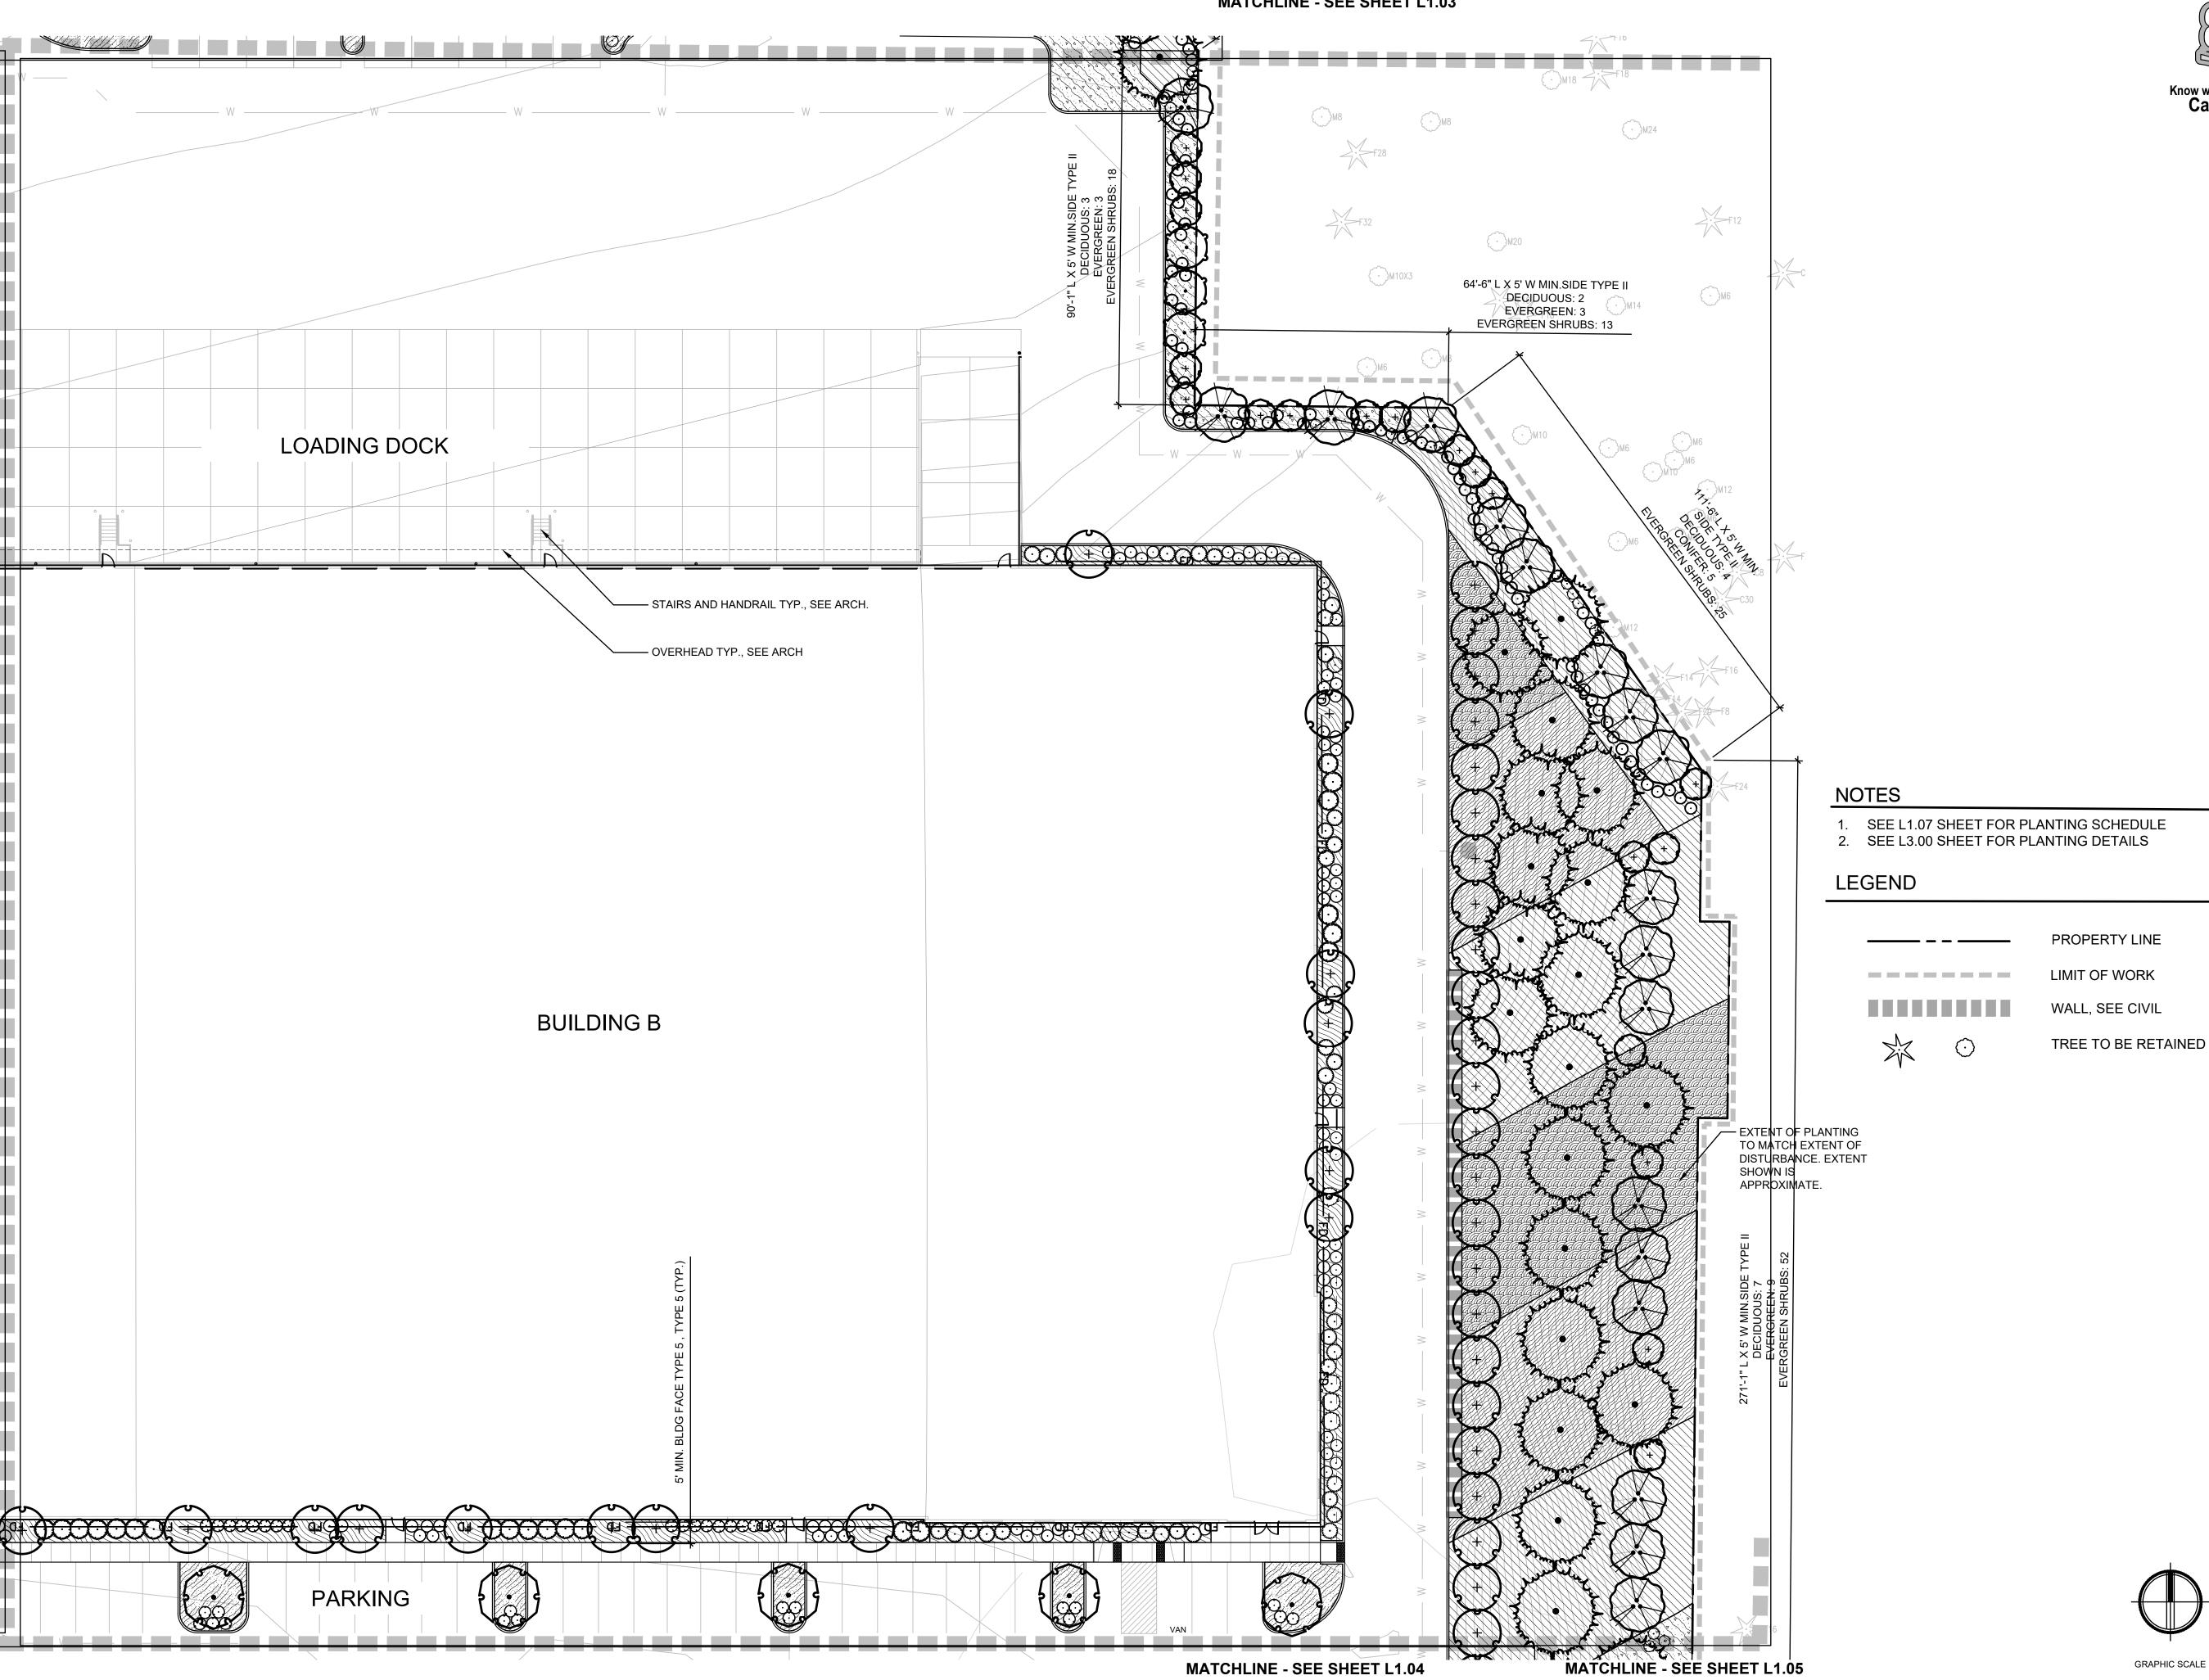





1200 6th Avenue, Suite1620,Seattle, WA 98101 206.267.2425 TEL 206.267.2429 FAX www.ahbl.com WEB

Project Title:

BRIDGE POINT SEATAC 300

BRIDGE DEVELOPMENT PARTNERS, LLC

> 10655 NE 4TH STREET, SUITE 500 BELLEVUE, WA 98004 KYLE SIEKAWITCH PH: (425) 749-4325


2200531.40

Issue Set & Date:

SITE DEVELOPMENT PERMIT SET

03/11/22



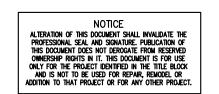


REVISED 06/06/2022 SEPA RESPONSES


REVISED 02/25/2022 SEPA RESPONSES

REVISED 7/16/2021 PER CITY OF SEATAC COMMENTS DATED 5/28/2021

HS/EH/SW

Sheet No.

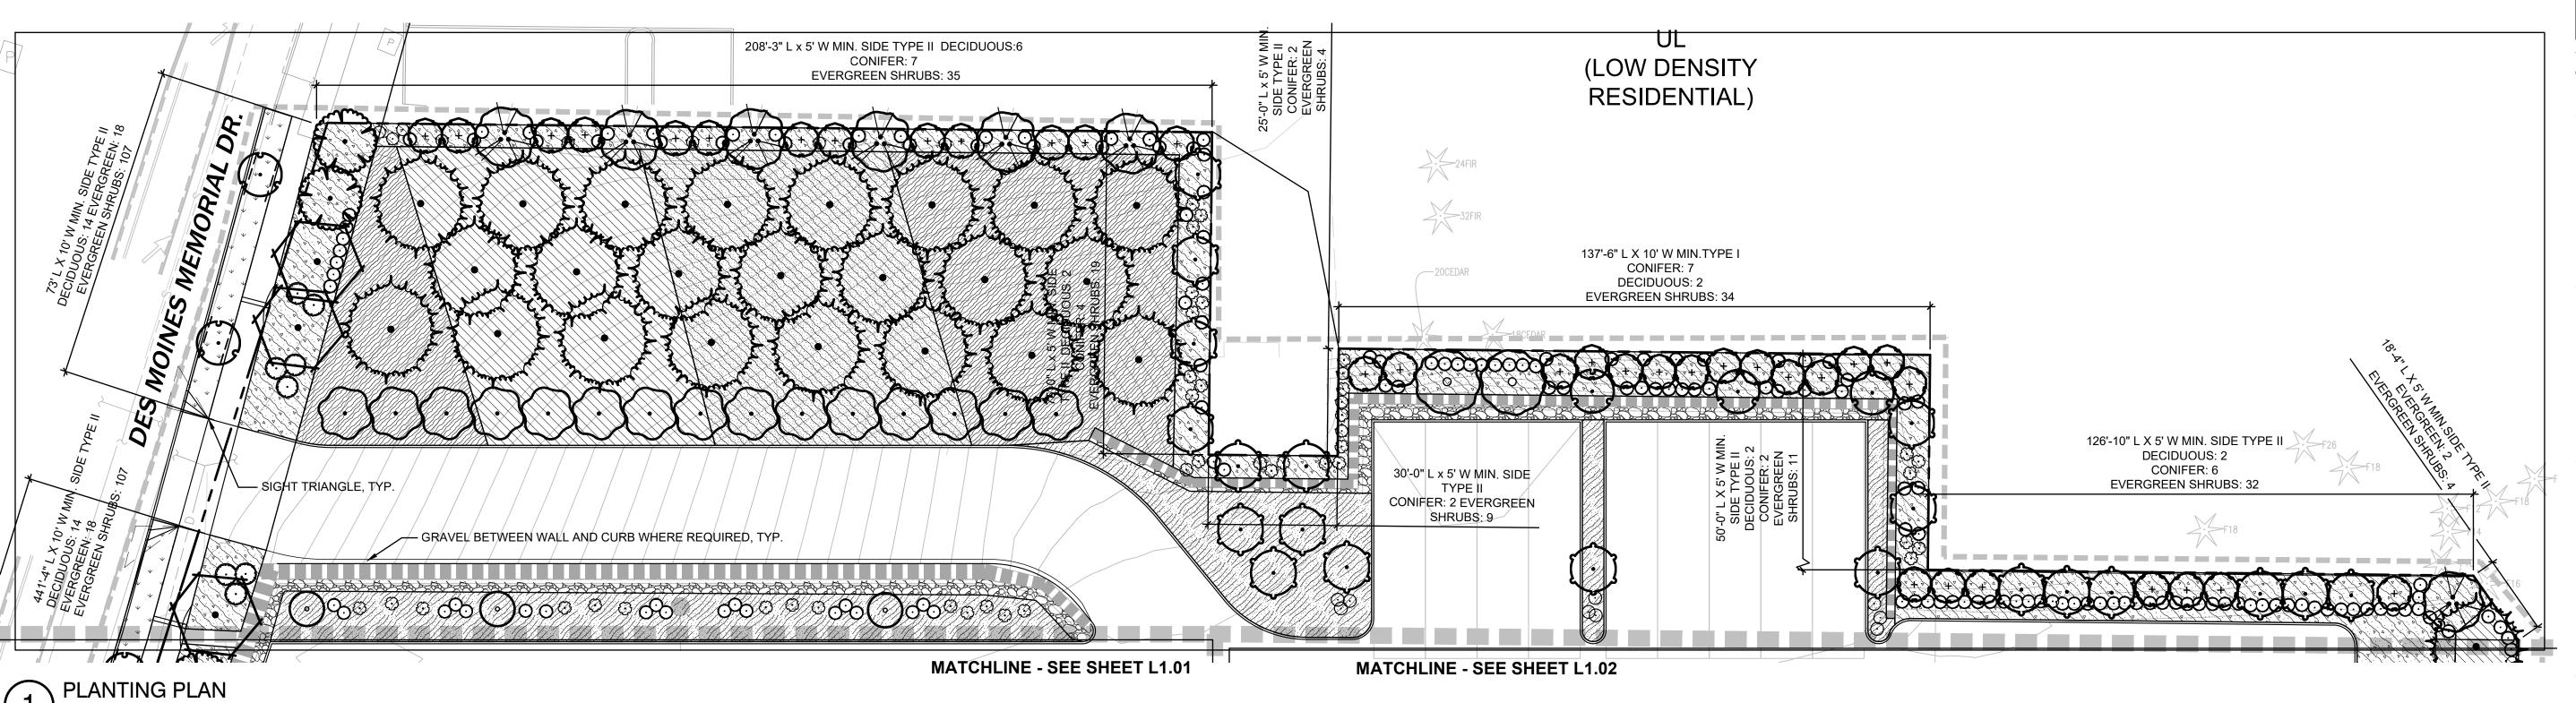

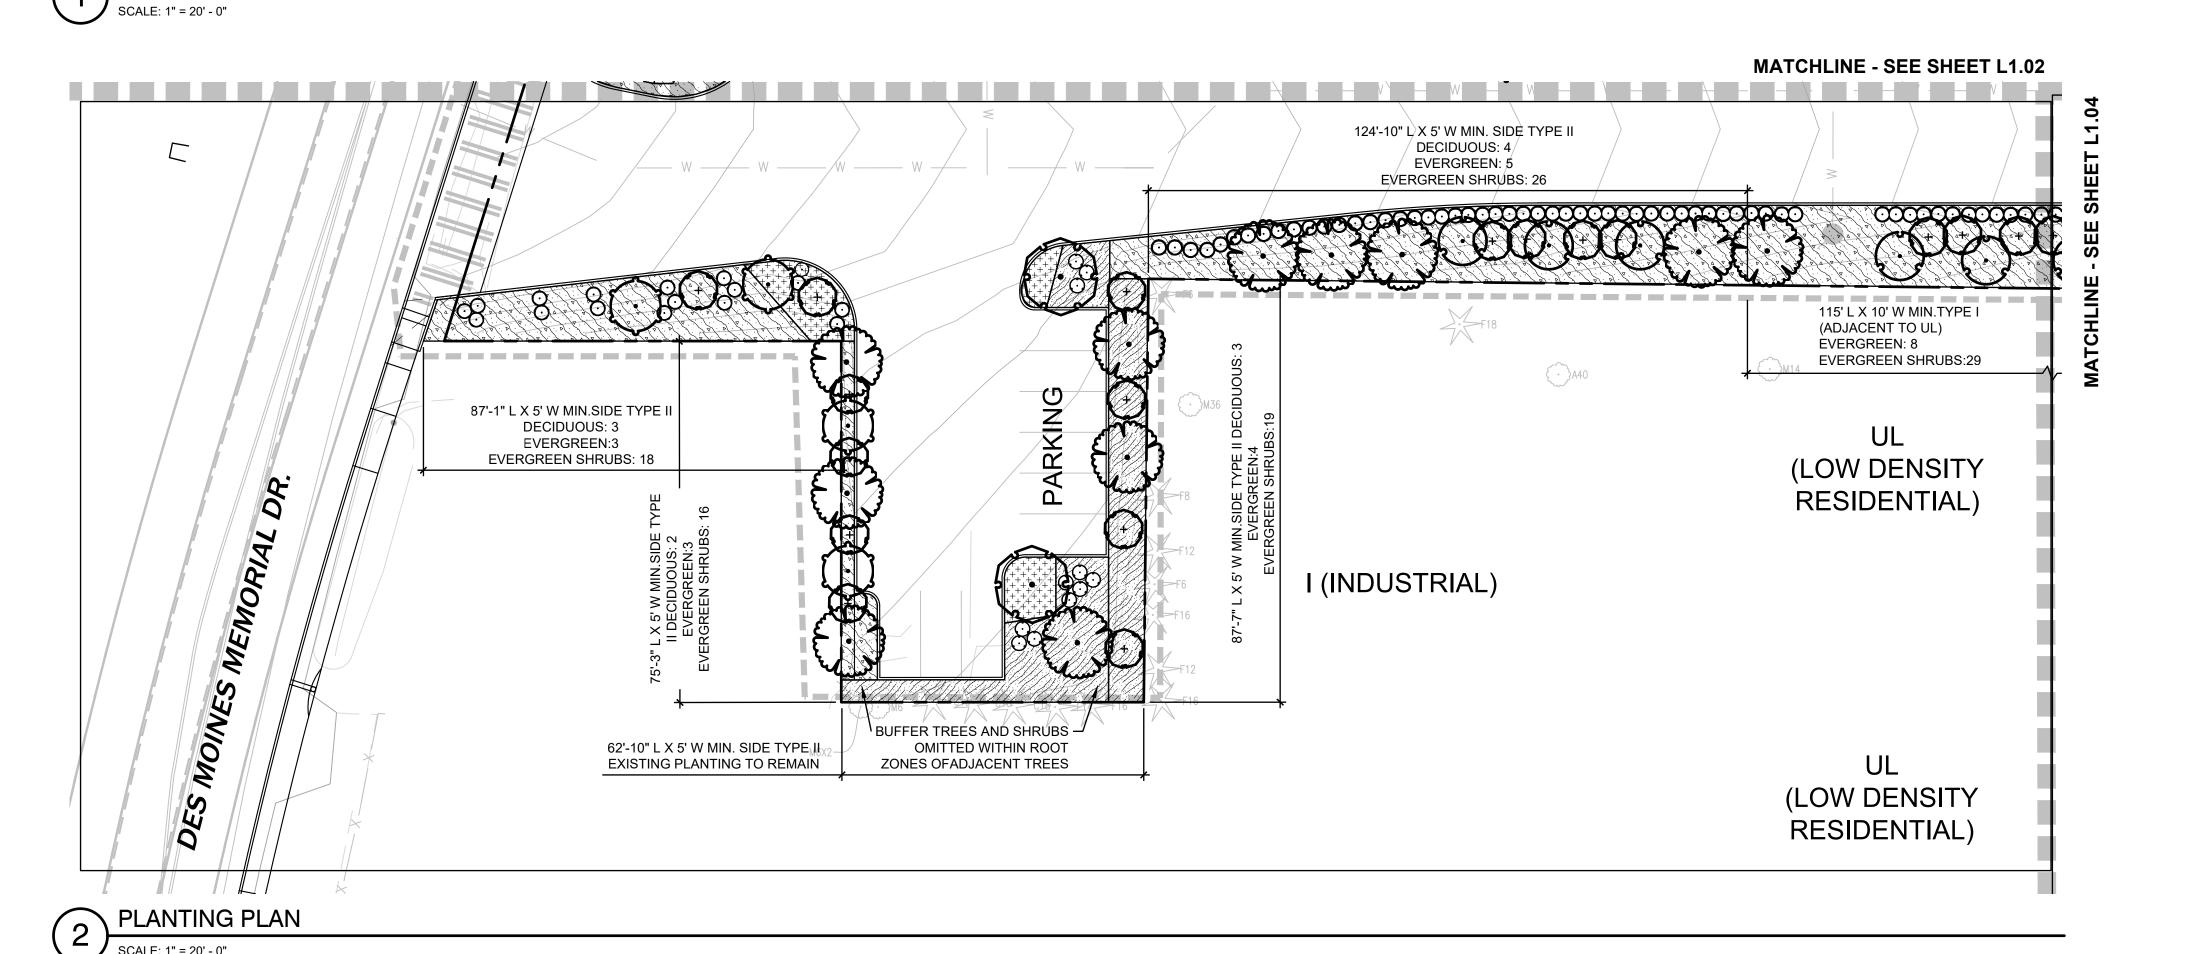

SCALE: 1" = 20' - 0"

NOTES SEE L1.07 SHEET FOR PLANTING SCHEDULE SEE L3.00 SHEET FOR PLANTING DETAILS

LEGEND

PROPERTY LINE

LIMIT OF WORK WALL, SEE CIVIL

TREE TO BE RETAINED

1" = 20 FEET

REVISED 01/21/2022 PER CITY OF SEATAC COMMENTS DATED 01/14/2022

REVISED 10/11/2021 PER CITY OF SEATAC COMMENTS DATED 9/3/2021

Sheet Title:

PLANTING PLAN

Designed by:







BRIDGE POINT SEATAC 300

Project Title:

BRIDGE DEVELOPMENT PARTNERS, LLC

> 10655 NE 4TH STREET, SUITE 500 BELLEVUE, WA 98004 KYLE SIEKAWITCH PH: (425) 749-4325

Project No.


2200531.40

Issue Set & Date:

SITE DEVELOPMENT PERMIT SET

03/11/22



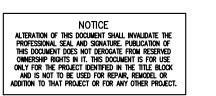

TREE TO BE RETAINED

PROPERTY LINE

LIMIT OF WORK

WALL, SEE CIVIL

REVISED 06/06/2022 SEPA RESPONSES

REVISED 02/25/2022 SEPA RESPONSES


REVISED 01/21/2022 PER CITY OF SEATAC COMMENTS DATED 01/14/2022

REVISED 10/11/2021 PER CITY OF SEATAC COMMENTS DATED 9/3/2021

REVISED 7/16/2021 PER CITY OF SEATAC COMMENTS DATED 5/28/2021


Sheet Title:

PLANTING PLAN

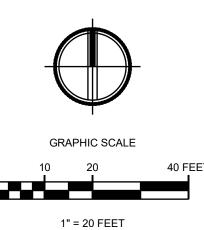

Designed by: MS

HS/EH/SW

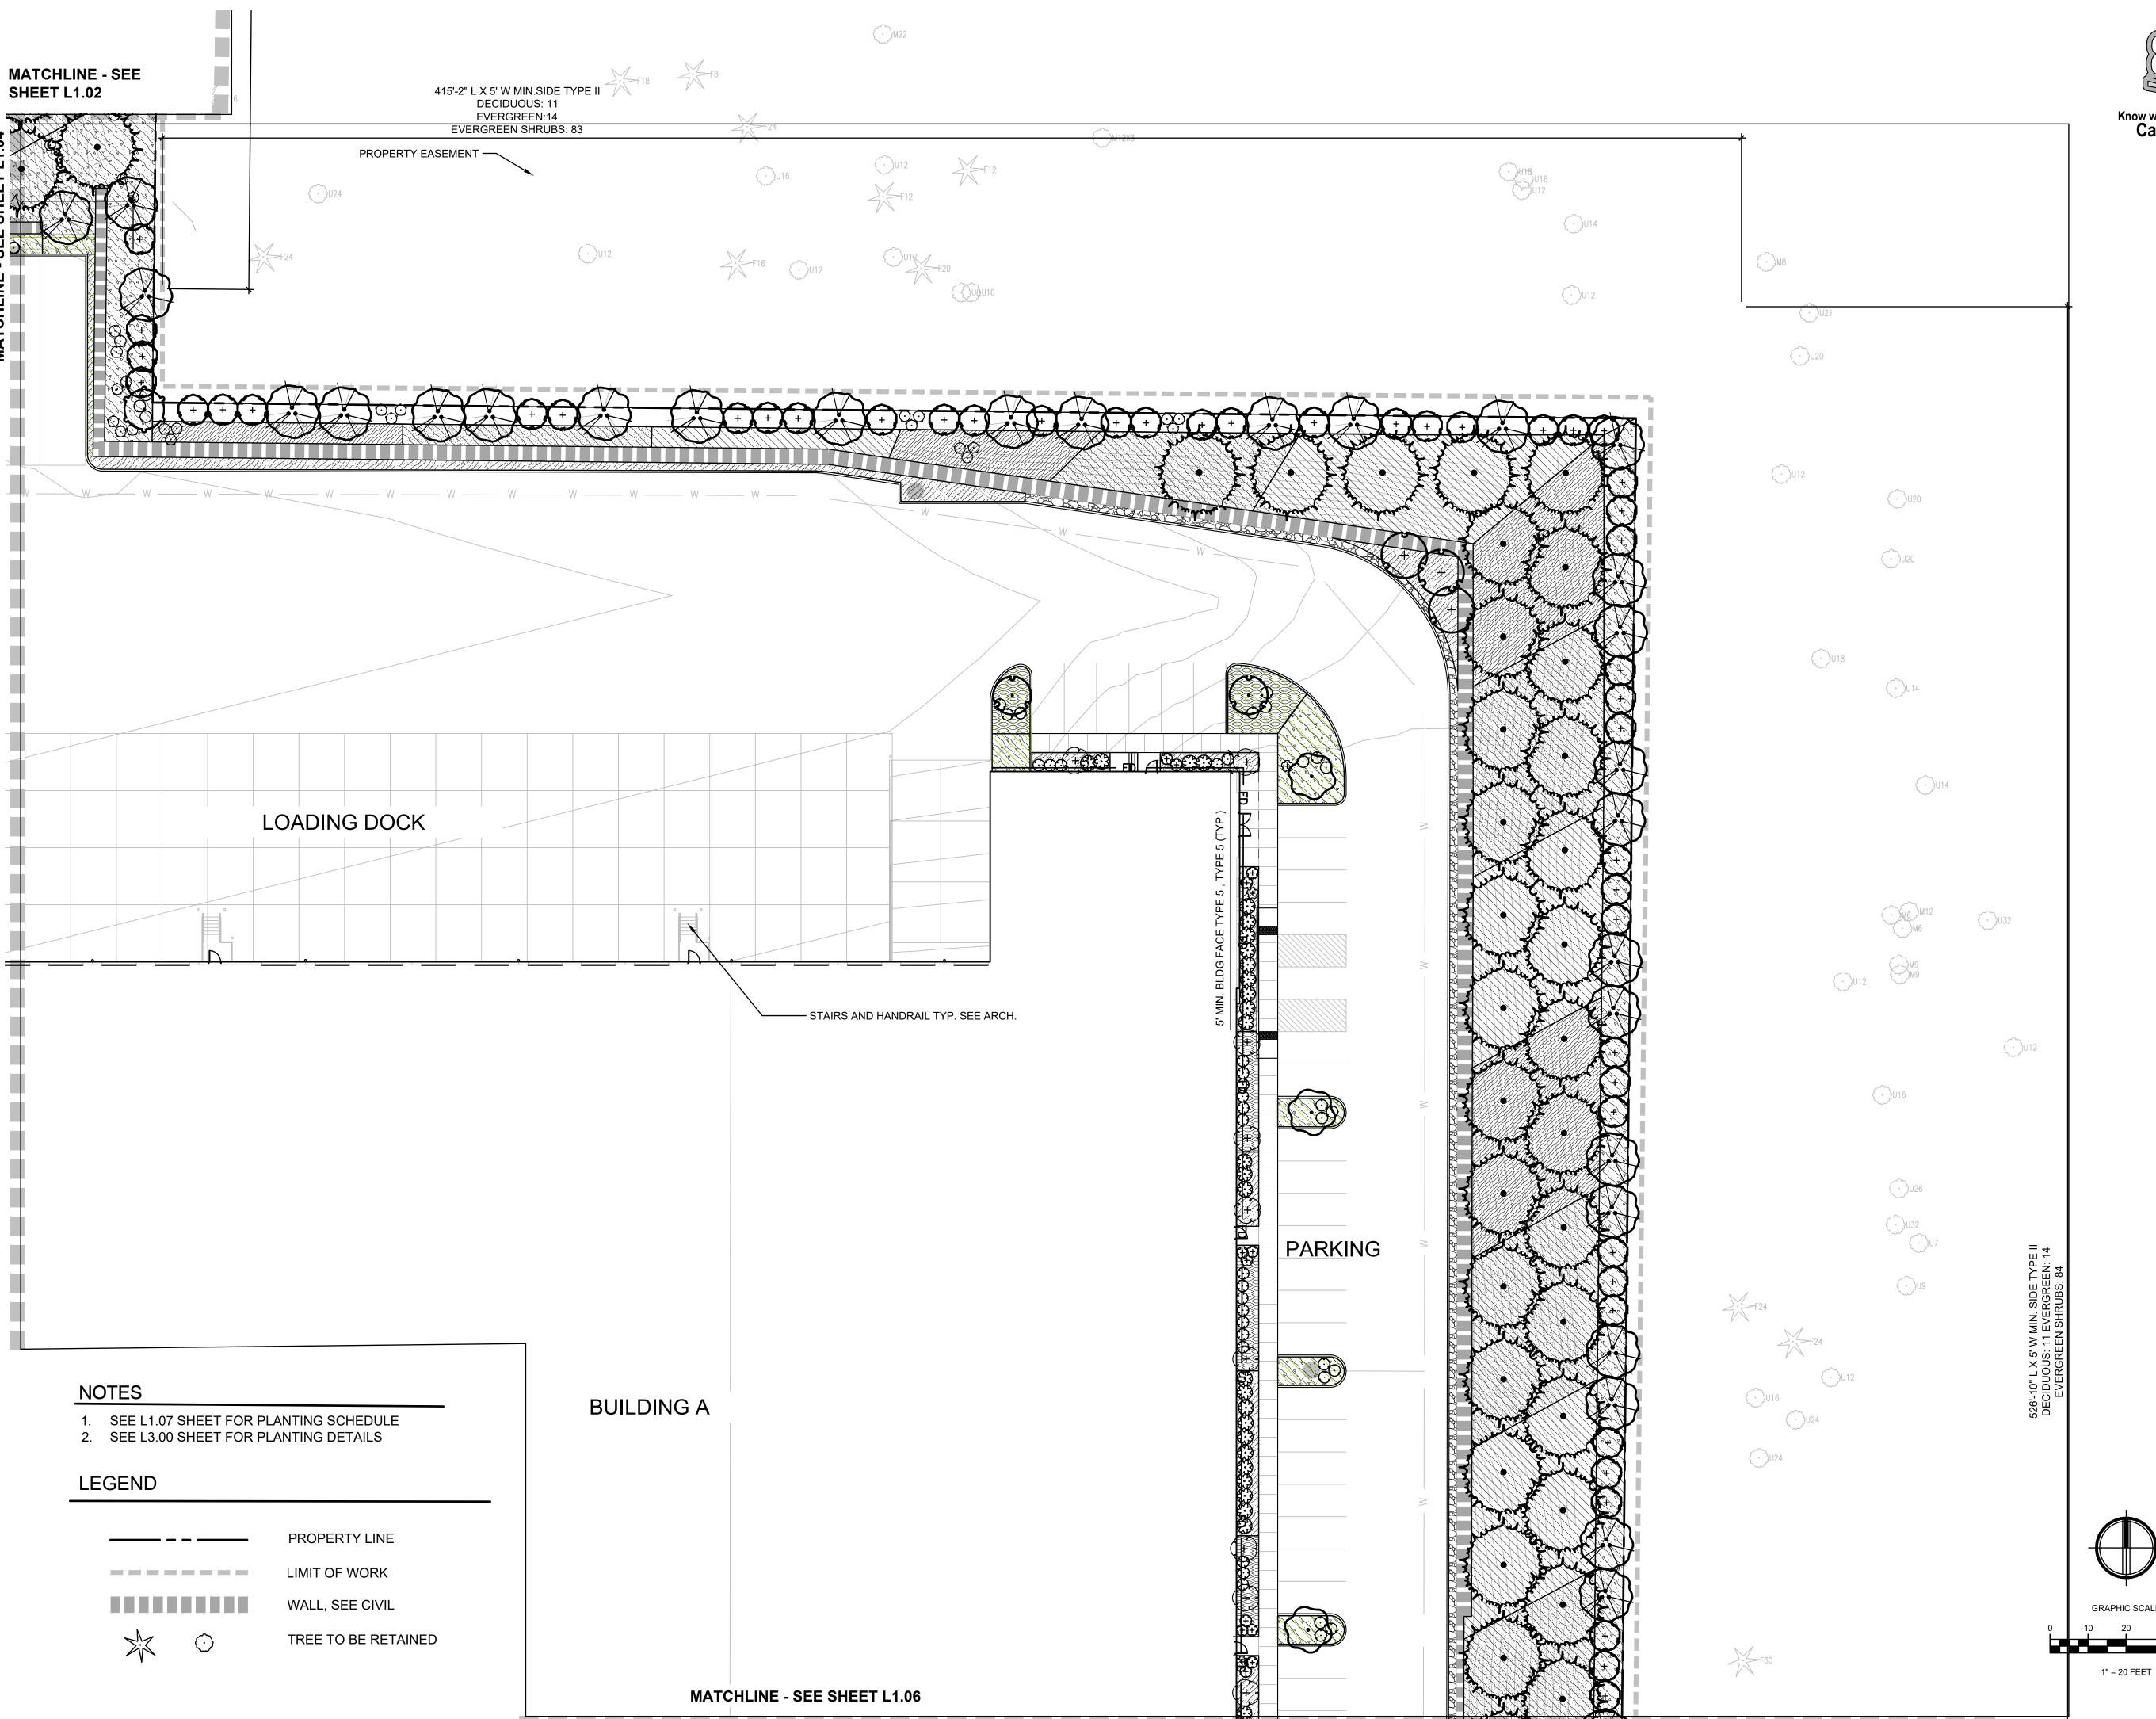





BRIDGE POINT SEATAC 300

BRIDGE DEVELOPMENT PARTNERS, LLC

10655 NE 4TH STREET, SUITE 500 BELLEVUE, WA 98004 KYLE SIEKAWITCH PH: (425) 749-4325

Project No.


2200531.40

Issue Set & Date:

SITE DEVELOPMENT PERMIT SET

03/11/22



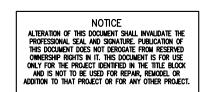

REVISED 06/06/2022 SEPA RESPONSES

REVISED 02/25/2022 SEPA RESPONSES


REVISED 01/21/2022 PER CITY OF SEATAC COMMENTS DATED 01/14/2022

REVISED 10/11/2021 PER CITY OF SEATAC COMMENTS DATED 9/3/2021

REVISED 7/16/2021 PER CITY OF SEATAC COMMENTS DATED 5/28/2021

Sheet Title:

PLANTING PLAN

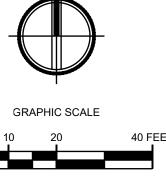

Designed by:

HS/EH/SW

Sheet No.

PLANTING PLAN



NOTES

LEGEND

1. SEE L1.07 SHEET FOR PLANTING SCHEDULE 2. SEE L3.00 SHEET FOR PLANTING DETAILS

PROPERTY LINE

LIMIT OF WORK

WALL, SEE CIVIL

TREE TO BE RETAINED



1200 6th Avenue, Suite1620, Seattle, WA 98101 206.267.2425 TEL 206.267.2429 FAX www.ahbl.com WEB

Project Title:

BRIDGE POINT SEATAC 300

BRIDGE DEVELOPMENT PARTNERS, LLC

10655 NE 4TH STREET, SUITE 500 BELLEVUE, WA 98004 KYLE SIEKAWITCH PH: (425) 749-4325

Project No.


2200531.40

Issue Set & Date:

SITE DEVELOPMENT **PERMIT SET**

03/11/22



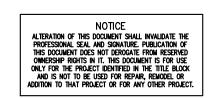

REVISED 06/06/2022 SEPA RESPONSES

REVISED 02/25/2022 SEPA RESPONSES

REVISED 01/21/2022 PER CITY OF SEATAC COMMENTS DATED 01/14/2022

REVISED 10/11/2021 PER CITY OF SEATAC COMMENTS DATED 9/3/2021


REVISED 7/16/2021 PER CITY OF SEATAC COMMENTS DATED 5/28/2021

Sheet Title:

PLANTING PLAN

HS/EH/SW

Sheet No.

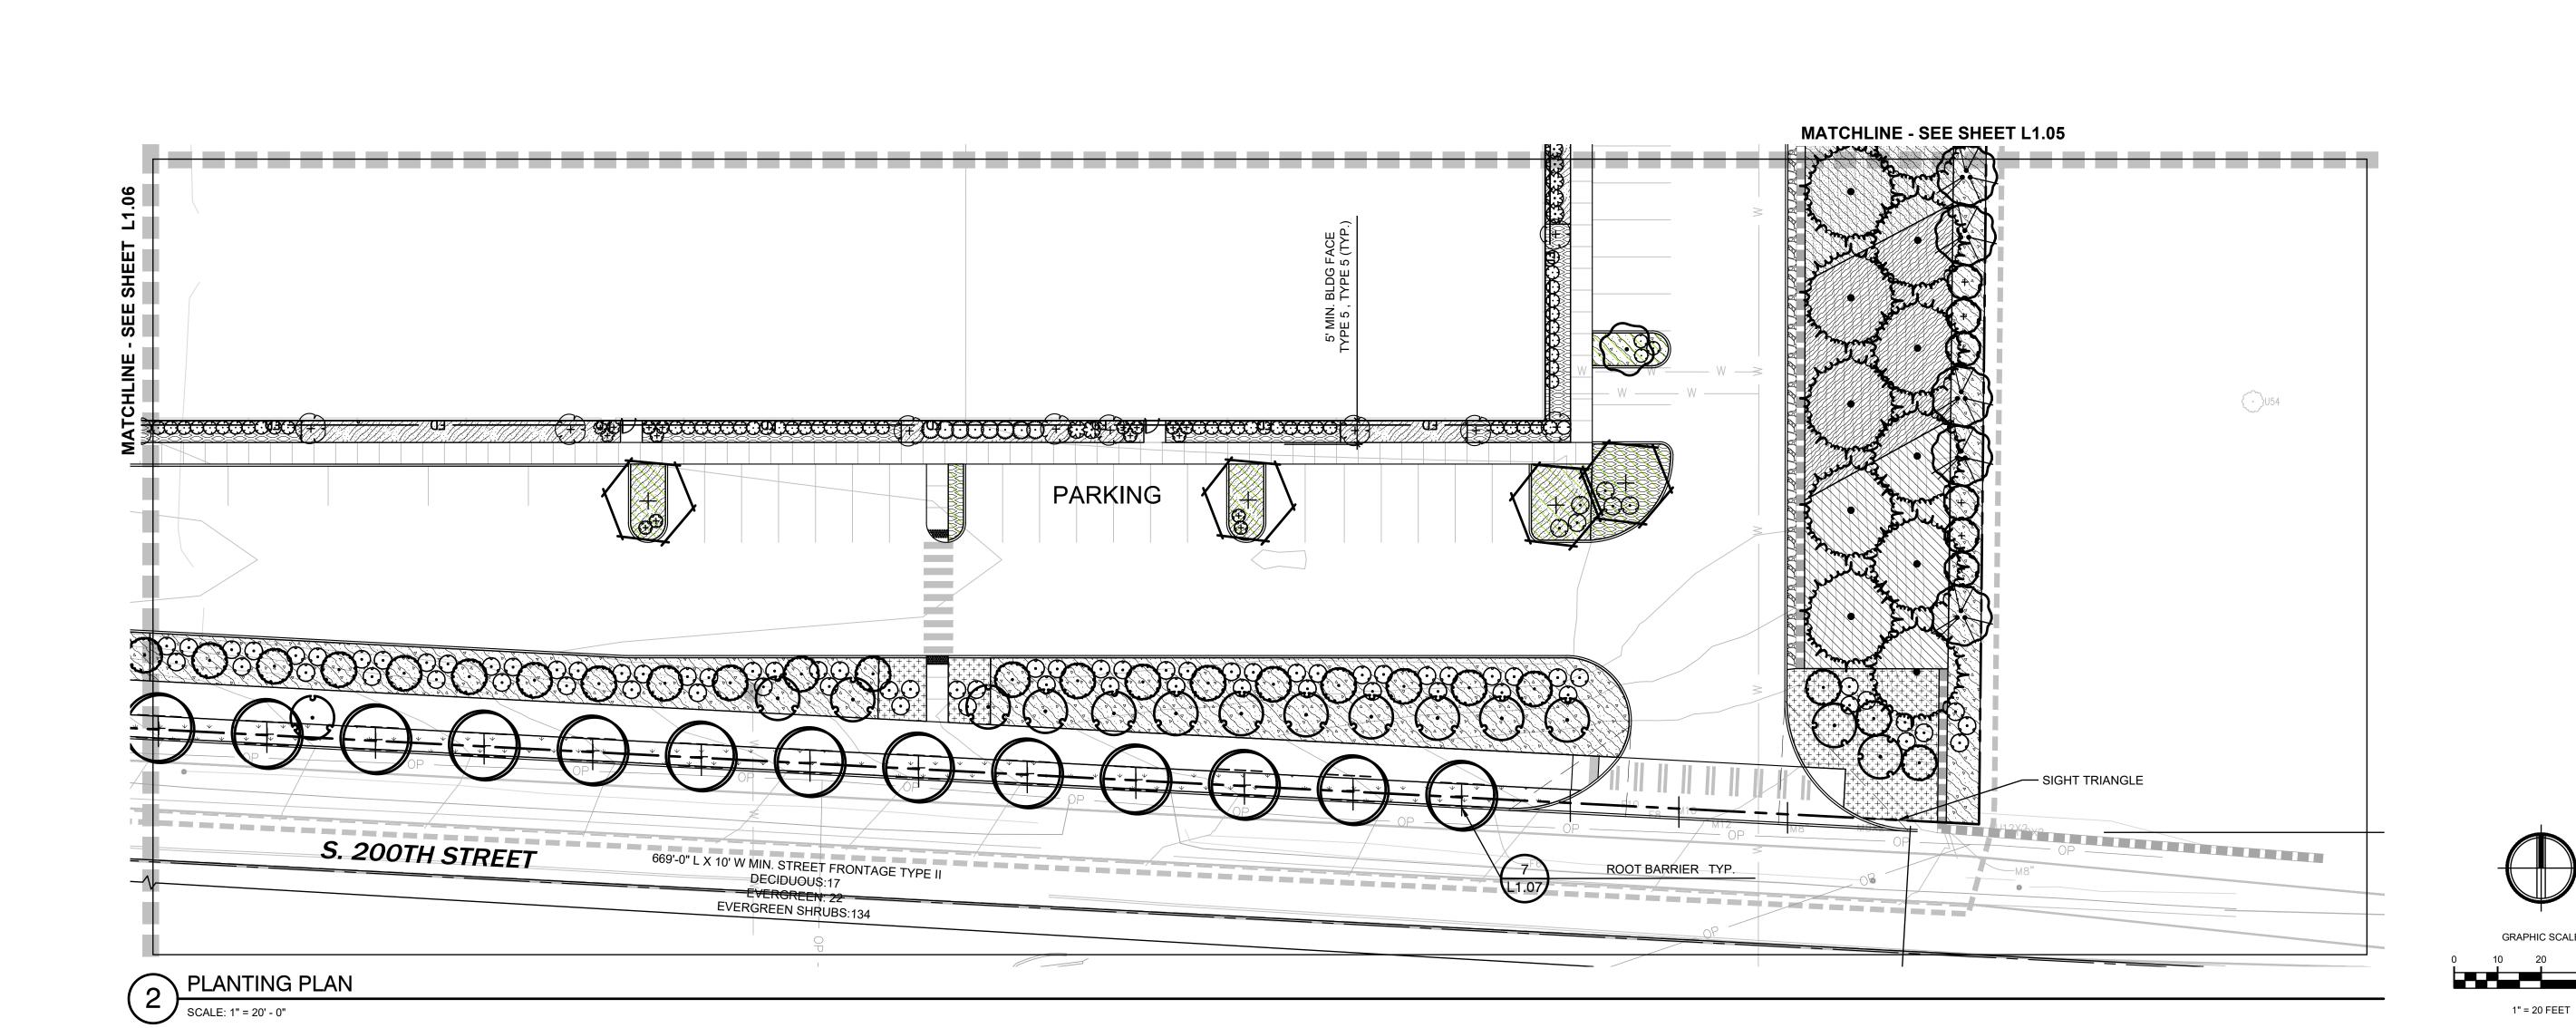

PLANT S				2022-0	06-06 13:1 ⁻
TREES	CODE	BOTANICAL NAME	COMMON NAME	PLANTING SIZE	QTY
0	AC	ACER CIRCINATUM	VINE MAPLE	2" CAL.	2
	AC3	ACER CIRCINATUM	VINE MAPLE	5` HT. MULTI-STEM	58
	AA	ACER RUBRUM 'ARMSTRONG'	ARMSTRONG RED MAPLE	2" CAL	48
	AU2	ACER TRUNCATUM X PLATANOIDES 'JFS-KW187' TM	URBAN SUNSET MAPLE	2" CAL.	10
+	AG	AMELANCHIER X GRANDIFLORA 'AUTUMN BRILLIANCE'	AUTUMN BRILLIANCE APPLE SERVICEBERRY	2" CAL	24
	CD	CALOCEDRUS DECURRENS	INCENSE CEDAR	8` HT. MIN.	43
+	CJ	CERCIDIPHYLLUM JAPONICUM	KATSURA TREE	2" CAL	10
	CR	CORNUS KOUSA X NUTTALLII 'KN144-2' TM	ROSY TEACUPS DOGWOOD	2" CAL	15
0	JS	JUNIPERUS SCOPULORUM 'SKYROCKET'	SKYROCKET JUNIPER	8` HT. MIN.	89
3	LN	LAGERSTROEMIA INDICA X FAURIEI 'NATCHEZ'	NATCHEZ CRAPE MYRTLE	2" CAL	33
+	LI	LAGERSTROEMIA INDICA X FAURIEI 'TUSCARORA'	TUSCARORA CRAPE MYRTLE	2" CAL	46
	РО	PICEA OMORIKA	SERBIAN SPRUCE	8` HT. MIN.	34
	PE	POPULUS TREMULA 'ERECTA'	EUROPEAN COLUMNAR ASPEN	2" CAL	20
إيماميرا	PD	PSEUDOTSUGA MENZIESII	DOUGLAS FIR	2" CAL	86
	SI	SYRINGA RETICULATA 'IVORY SILK'	IVORY SILK JAPANESE TREE LILAC	2" CAL.	19
	TG	THUJA STANDISHII X PLICATA 'GREEN GIANT'	GREEN GIANT ARBORVITAE	8` HT. MIN.	154
•	ZA	ZELKOVA SERRATA	JAPANESE ZELKOVA	2" CAL.	20
SHRUBS	CODE	BOTANICAL NAME	COMMON NAME	<u>SIZE</u>	QTY
\odot	AC2	ARBUTUS UNEDO 'COMPACTA'	COMPACT STRAWBERRY TREE	5 GAL	39
\odot	СТ	CHOISYA TERNATA	MEXICAN ORANGE	3 GAL	138
(+)	KJ	KERRIA JAPONICA	JAPANESE KERRIA	3 GAL	32
£;3	LP	LONICERA PILEATA	PRIVET HONEYSUCKLE	1 GAL	76
\odot	MA	MAHONIA AQUIFOLIUM	OREGON GRAPE	1 GAL	607
$\overline{(\cdot)}$	МС	MORELLA CALIFORNICA	CALIFORNIA WAX MYRTLE	3 GAL	21
\odot	NG	NANDINA DOMESTICA 'GULF STREAM' TM	GULF STREAM HEAVENLY BAMBOO	1 GAL	146
\odot	RU	RHAPHIOLEPIS UMBELLATA 'MINOR' TM	GULF GREEN INDIAN HAWTHORN	1 GAL	143
\odot	RK	RIBES SANGUINEUM 'KING EDWARD VII'	RED FLOWERING CURRANT	3 GAL	98
\odot	ST	SPIRAEA BETULIFOLIA 'TOR'	TOR BIRCHLEAF SPIREA	1 GAL	76
0	VD	VIBURNUM DAVIDII	DAVID VIBURNUM	2 GAL	91
⊕	YC	YUCCA FILAMENTOSA 'COLOR GUARD'	COLOR GUARD ADAM'S NEEDLE	1 GAL	71
*01101100 (פטאון פר	24" HT. MINIMUM			

PLANT SCHEDULE

GROUND COVERS	CODE	BOTANICAL NAME	COMMON NAME	SIZE	SPACING 20	022-06-06 13:11 QTY
SA SA SA	AU	ARCTOSTAPHYLOS UVA-URSI	KINNIKINNICK	1 GAL	24" o.c.	8,436
स्मायसम्बद्धाः बित्वविविविवि विविविविविविविविविविविविविविव	CW	CORNUS SERICEA 'KELSEYI'	KELSEYI DWARF RED-OSIER DOGWOOD	1 GAL	24" o.c.	1,061
	FL	FRAGARIA X 'LIPSTICK'	LIPSTICK STRAWBERRY	1 GAL	36" o.c.	255
	GS	GAULTHERIA SHALLON	SALAL	1 GAL	24" o.c.	2,707
	НВ	HELIANTHEMUM NUMMULARIUM 'BEN NEVIS'	BEN NEVIS ROCK ROSE	1 GAL	24" o.c.	11
+++++++ +++++++ ++++++++ +++++++ ++++++	РВ	PENNISETUM ALOPECUROIDES 'LITTLE BUNNY'	LITTLE BUNNY FOUNTAIN GRASS	1 GAL	24" o.c.	675
	PM	POLYSTICHUM MUNITUM	WESTERN SWORD FERN	2 GAL	36" o.c.	2,996
	PL	PRUNUS LAUROCERASUS 'MOUNT VERNON'	MOUNT VERNON ENGLISH LAUREL	1 GAL	36" o.c.	604
	RG	RHUS AROMATICA 'GRO-LOW'	GRO-LOW FRAGRANT SUMAC	3 GAL	48" o.c.	1,076
	RN	RUBUS CALYCINOIDES	CREEPING BRAMBLE	1 GAL	24" o.c.	3,647
\ \ \ \ \ \ \ \ \ \ \ \ \ \ \ \ \ \ \	TS	TURF SOD	COUNTRY GREEN - VERSA GREEN TURF	SOD		5,967 SF





1200 6th Avenue, Suite1620,Seattle, WA 98101 206.267.2425 TEL 206.267.2429 FAX www.ahbl.com WEB

Project Title:

BRIDGE POINT SEATAC 300

Client:
BRIDGE DEVELOPMENT PARTNERS, LLC

> 10655 NE 4TH STREET, SUITE 500 BELLEVUE, WA 98004 KYLE SIEKAWITCH PH: (425) 749-4325

Project No.


2200531.40

Issue Set & Date:

SITE DEVELOPMENT PERMIT SET

03/11/22



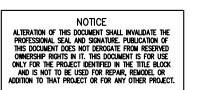

REVISED 06/06/2022 SEPA RESPONSES

REVISED 02/25/2022 SEPA RESPONSES

REVISED 01/21/2022 PER CITY OF SEATAC COMMENTS DATED 01/14/2022

REVISED 10/11/2021 PER CITY OF SEATAC COMMENTS DATED 9/3/2021

REVISED 7/16/2021 PER CITY OF SEATAC COMMENTS DATED 5/28/2021


Sheet Title:


PLANTING SCHEDULE

Drawn by: HS/EH/SW

Sheet No.


L1.07 16 of 19heets

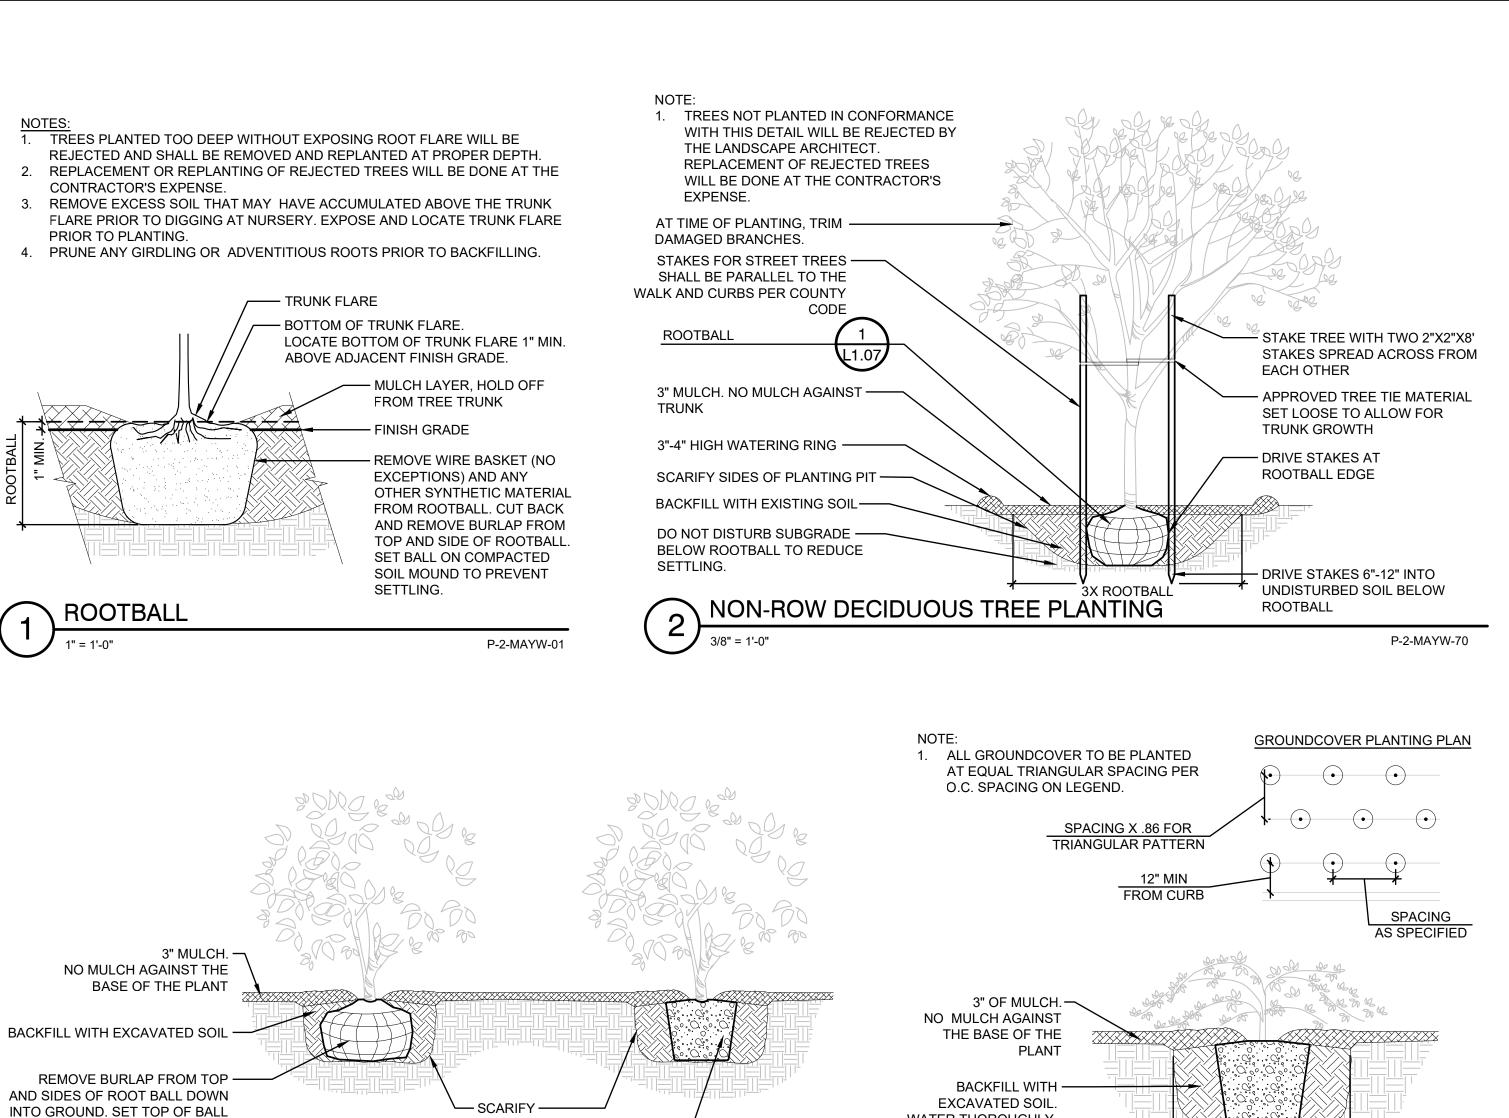

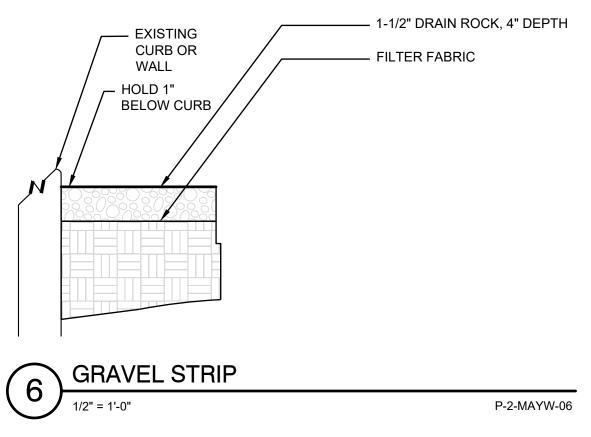

(TYP.)

NON-ROW CONIFER TREE PLANTING W/ STAKE

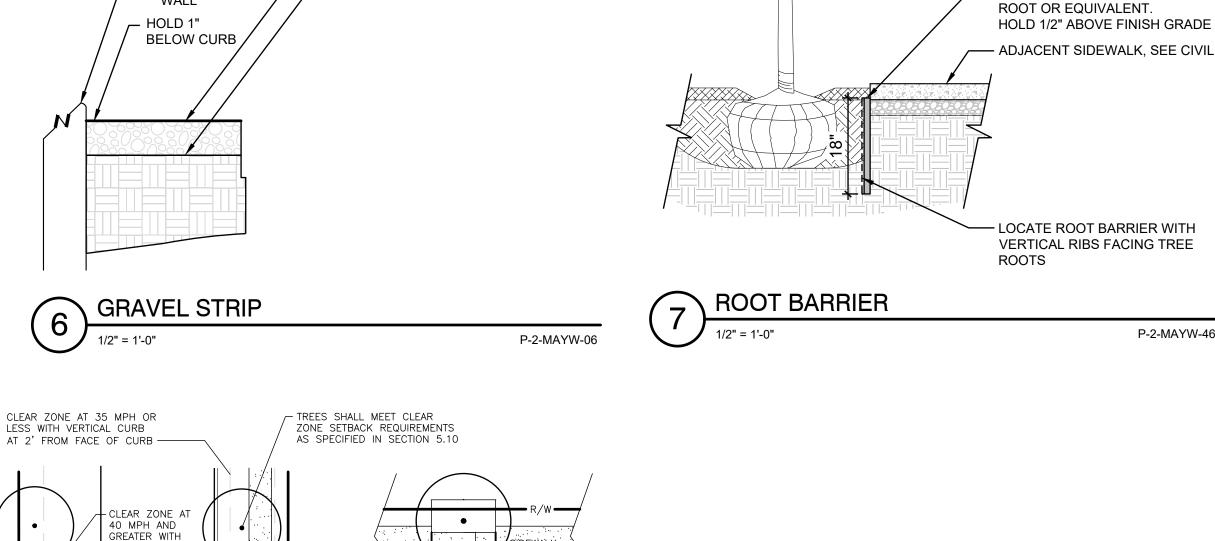

TREE BLOCKOUTS

PLACE ROCKERY AT BACK OF

SIDEWALK TO ELIMINATE WEED

STRIP WHEN POSSIBLE.

SIDEWALK

ROCKERIES AT SIDEWALK

- AT TIME OF PLANTING,

TRIM DAMAGED

- STAKE TREE WITH

SPREAD ACROSS

FROM EACH OTHER.

APPROVED TREE TIE

MATERIAL SET LOOSE

TO ALLOW FOR

TRUNK GROWTH

- DRIVE STAKES AT

ROOTBALL EDGE

DRIVE STAKES 6"-12"

INTO UNDISTURBED

P-2-MAYW-71

1. SEE PLANTING PLANS FOR LOCATIONS

2. INSTALL PER MANUFACTURER'S INSTRUCTIONS.

SOIL BELOW

ROOTBALL

TWO 2"X2"X8' STAKES

BRANCHES.



- UB 18-2 ROOT BARRIER BY DEEP

P-2-MAYW-46



1200 6th Avenue, Suite1620, Seattle, WA 98101 206.267.2425 TEL 206.267.2429 FAX www.ahbl.com WEB

Project Title:

BRIDGE POINT SEATAC 300

BRIDGE DEVELOPMENT PARTNERS, LLC


10655 NE 4TH STREET, SUITE 500 BELLEVUE, WA 98004 KYLE SIEKAWITCH PH: (425) 749-4325

Project No.


2200531.40

Issue Set & Date:

SITE DEVELOPMENT **PERMIT SET**

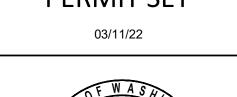



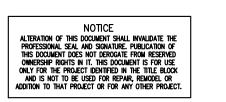

REVISED 06/06/2022 SEPA RESPONSES

REVISED 02/25/2022 SEPA RESPONSES

REVISED 01/21/2022 PER CITY OF SEATAC COMMENTS DATED 01/14/2022

REVISED 10/11/2021 PER CITY OF SEATAC COMMENTS DATED 9/3/2021


REVISED 7/16/2021 PER CITY OF SEATAC COMMENTS DATED 5/28/2021

Sheet Title:

PLANTING DETAILS

HS/EH/SW

18 of 19heets

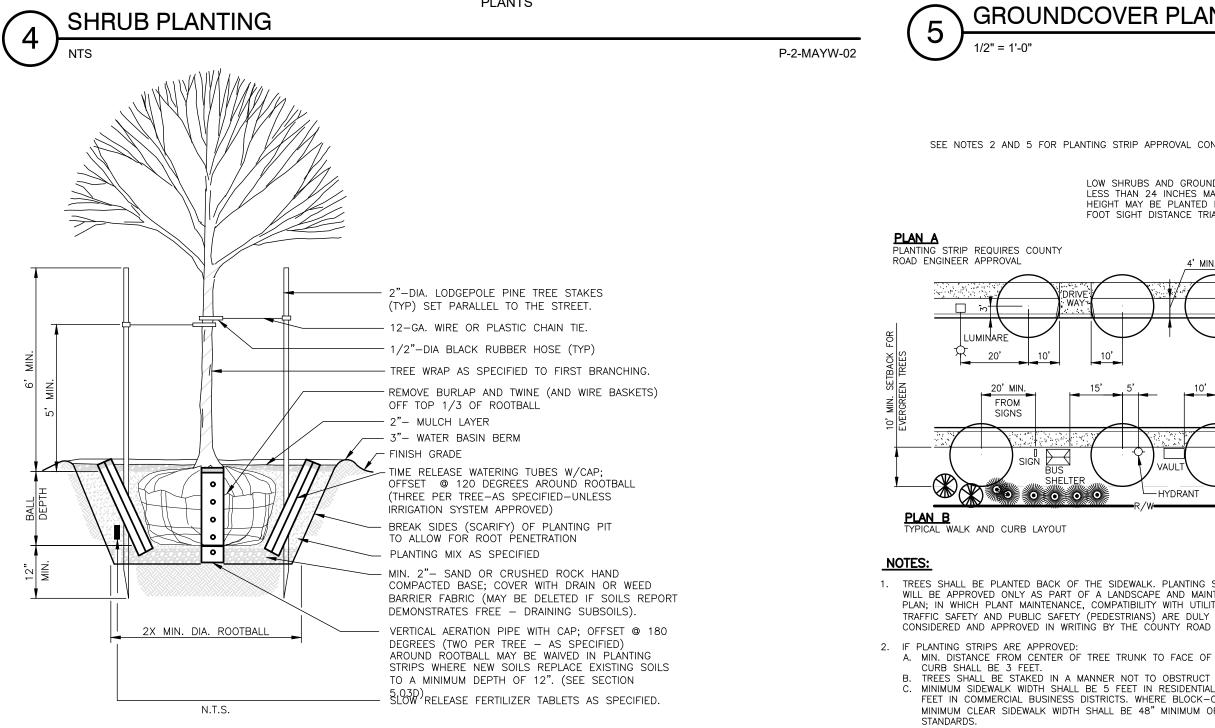

SIDES OF

1. PLANT TREES 1 INCH HIGHER THAN DEPTH GROWN IN NURSERY. TREE PIT SHALL NOT BE LESS THAN (2) TIMES DIAMETER OF ROOTBALL.

2. ROOTBARRIER SHALL BE 12 INCHES DEEP AND MINIMUM 10 L.F. ON EACH

SIDE OF ROOTBALL ADJACENT TO CURBS AND PAVED SURFACES.

3. THERE SHALL BE A MINIMUM ROOTBALL DIAMETER OF 10 INCHES PER TRUNK

4. IF APPLICANT PROPOSES AN IRRIGATION PLAN WITHIN AN APPROVED PLANTING STRIP, TO BE PRIVATELY MAINTAINED (PER NOTE No. 1 FIG. 5-009), THE TIME RELEASE WATERING TUBES MAY BE DELETED.

CALIPER INCH AS MEASURED 6 INCHES ABOVE ROOTBALL.

8 ROW ONLY - TREE PLANTING IN PLANTING STRIPS


NTS

PLANTING PIT

LOOSEN / PULL OUT ROOTS-

FROM CONTAINER GROWN

FLUSH WITH FINISH GRADE.

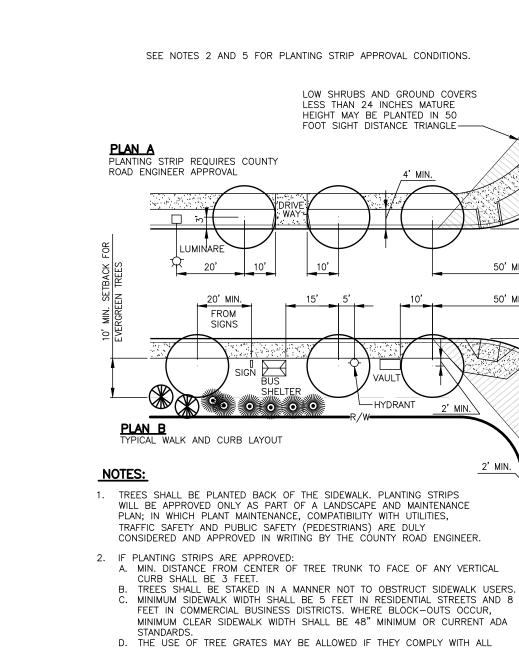

WATER THOROUGHLY

P-2-MAYW-66

GROUNDCOVER PLANTING

A. MIN. DISTANCE FROM CENTER OF TREE TRUNK TO FACE OF ANY VERTICAL CURB SHALL BE 3 FEET.

D. THE USE OF TREE GRATES MAY BE ALLOWED IF THEY COMPLY WITH ALL 3. PLANS SHALL BE COORDINATED WITH KING COUNTY METRO SERVICE PLANNING ON BUS ROUTES.

THE RIGHT-OF-WAY SHALL HAVE A MATURE HEIGHT LESS THAN 24 INCHES.

4. SEE SEC 5.03 FOR ADDITIONAL STREET TREE AND LANDSCAPE REQUIREMENTS. 5. NO TREES WITH MATURE TRUNKS GREATER THAN 4 INCHES DIAMETER (AS MEASURED AT GRADE) SHALL BE PLANTED WITHIN THE KING COUNTY CLEAR ZONE. LARGER TREES MAY BE APPROVED FOR PLANTING OUTSIDE THE CLEAR ZONE AREA. NO TREES SHALL BE PLANTED WITHIN THE 50 FOOT SIGHT DISTANCE TRIANGLE AT INTERSECTIONS. ALL SHRUB AND GROUND COVER PLANTINGS WITHIN



P-2-MAYW-03

ROW ONLY - TREE SETBACKS AT SIDEWALK P-2-MAYW-07

1. ROOTBARRIERS REQUIRED FOR ALL TREES IN PLANTER STRIP (UNLESS WAIVED BY K.C.D.O.T.)

CLEAR

4' PLANTER STRIP MINIMUM IN

MINIMUM ON ARTERIALS AS APPROVED BY COUNTY ROAD

RESIDENTIAL ST. AND 5'

NOTES:

ROOTBALL

1. TREES NOT PLANTED IN CONFORMANCE WITH THIS

DETAIL WILL BE REJECTED BY THE LANDSCAPE

2. PLANTING INCLUDES REMOVAL OF STAKES ONE YEAR

BE DONE AT THE CONTRACTOR'S EXPENSE.

AFTER INSTALLATION.

3" MULCH. NO MULCH AGAINST TRUNK —

3"-4" HIGH WATERING RING -

SCARIFY SIDES OF PLANTING PIT -

DO NOT DISTURB SUBGRADE BELOW -

ROOTBALL TO REDUCE SETTLING.

BACKFILL WITH EXISTING SOIL -

ARCHITECT. REPLACEMENT OF REJECTED TREES WILL

2. REFER TO FIG. 5-009 FOR SPECIFIC SETBACKS.

TREE SETBACKS

FROM FACE OF CURB OR FROM

TRAVELED WAY WHEN NO CURB. -

FACE OF CURB-

PLANTING SPECIFICATION

SITE PREPARATION

- 1. SEE CIVIL DRAWINGS FOR GRADING, AND UTILITY LOCATIONS AND DIMENSIONS. CONTRACTOR SHALL BE RESPONSIBLE FOR CONFIRMING LOCATION OF ALL UTILITIES. CALL FOR UTILITY LOCATIONS PRIOR TO DEMOLITION. CONSULT WITH ARCHITECT AND/ OR GENERAL CONTRACTOR PRIOR TO DEMOLITION.
- 2. CONTRACTOR SHALL NOTIFY THE OWNER'S REPRESENTATIVE OF ANY DISCREPANCIES FOUND IN PLANS OR DEVIATIONS FROM DOCUMENTED ON-SITE CONDITIONS. FAILURE TO NOTIFY THE OWNER'S REPRESENTATIVE IN A TIMELY MANNER SHALL RESULT IN CONTRACTOR ASSUMING RESPONSIBILITY FOR COSTS
- ASSOCIATED WITH ANY AND ALL REMEDIAL MEASURES REQUIRED. 3. CONTRACTOR AND ALL SUBCONTRACTORS SHALL CONFORM TO
- ALL STATE AND/OR LOCAL CODES. 4. CONTRACTOR SHALL INSTALL ALL PRODUCTS PER
- MANUFACTURERS SPECIFICATIONS.
- 5. IF UTILITIES ARE ENCOUNTERED, CONTRACTOR SHALL PROMPTLY INFORM BUILDING REPRESENTATIVE AND OWNER'S REPRESENTATIVE AND REPAIR ANY DAMAGES.
- 6. CONTRACTOR AND ALL SUBCONTRACTORS SHALL CLEAN UP ALL DEBRIS AND LEAVE SITE IN A NEAT AND ORGANIZED CONDITION DAILY. CONTRACTOR SHALL CLEAN ADJACENT SURFACES DAILY AS NECESSARY (COORDINATE WITH GENERAL CONTRACTOR FOR APPROVAL) DAILY.
- 7. CONTRACTOR SHALL SUBMIT LANDSCAPE PROJECT SCHEDULE TO LANDSCAPE ARCHITECT (L.A.), A MINIMUM OF 4 WEEKS PRIOR TO START OF ANY LANDSCAPE WORK.

BULK MATERIALS:

- 8. DO NOT DUMP OR STORE BULK MATERIALS NEAR STRUCTURES, UTILITIES, WALKWAYS AND PAVEMENTS OR ON EXISTING TURF AREAS OR PLANTS.
- 9. PROVIDE EROSION-CONTROL MEASURES TO PREVENT EROSION OR DISPLACEMENT OF BULK MATERIALS, DISCHARGE OF SOIL-BEARING WATER RUNOFF, AND AIRBORNE DUST REACHING ADJACENT PROPERTIES, WATER CONVEYANCE SYSTEMS, OR WALKWAYS.
- 10. DO NOT MOVE OR HANDLE MATERIALS WHEN THEY ARE SATURATED OR FROZEN.

PLANTING SOIL:

- 11. LANDSCAPE AREAS SHALL BE DEEP TILLED TO A DEPTH OF AT LEAST 12 INCHES TO FACILITATE DEEP WATER PENETRATION AND SOIL OXYGENATION.
- 12. FOR ALL NEWLY LANDSCAPED AREAS, 4 CUBIC YARDS OF COMPOST PER 1,000 SQUARE FEET OF LANDSCAPE AREA SHALL BE INCORPORATED TO A DEPTH OF AT LEAST 4 INCHES INTO TOPSOIL.
- 13. COMPOST SHALL BE COMPOST MULCH FROM CEDAR GROVE OR APPROVED EQUAL.
- 14. TOPSOIL SHALL BE ONE OF THE FOLLOWING, TESTED BY AN ACCREDITED SOIL TESTING FACILITY AND AMENDED BASED ON THEIR RECOMMENDATIONS:
- 14.1. SANDY LOAM TOPSOIL FROM CEDAR GROVE OR APPROVED
- 14.2. OR NATIVE STOCKPILED SOIL AMENDED TO SANDY LOAM, AND AS RECOMMENDED BY SOIL TEST, OR APPROVED BY LANDSCAPE ARCHITECT
- 15. FOR ALL NEWLY LANDSCAPED AREAS, TOPSOIL SHALL BE SPREAD TO A DEPTH AS SHOWN ON SOILS PLAN.

MULCHING.

- 16. MULCH SHALL BE APPLIED TO ALL PLANTING AREAS. MULCHES SHALL BE APPLIED TO THE FOLLOWING DEPTHS: 3 INCHES OVER BARE SOIL, AND 2 INCHES WHERE PLANT MATERIALS WILL COVER
- 17. MULCH TO BE FREE OF DELETERIOUS MATERIALS AND SUITABLE AS A TOP DRESSING OF TREES AND SHRUBS, CONSISTING OF COMPOSTED AGED (MIN. 1 YEAR) FIR OR HEMLOCK BARK CHIPS AND TO BE DARK (BLACK) IN COLOR, COMPOST MULCH TO BE WELL-COMPOSTED, STABLE AND WEED-FREE ORGANIC MATTER WITH ORGANIC MATTER COMPRISING 50 TO 60 PERCENT OF DRY
- 18. TOP OF MULCH SHALL BE FLUSH WITH FINISH GRADES. DO NOT PLACE MULCH WITHIN 2 INCHES OF TRUNKS OR STEMS.

PREPARATION:

- 19. CLEAN SOIL OF CONCRETE SLURRY, CONCRETE LAYERS OR CHUNKS, CEMENT, PLASTER, BUILDING DEBRIS, OILS, GASOLINE, DIESEL FUEL, PAINT THINNER, TURPENTINE, TAR, ROOFING COMPOUND, ACID AND OTHER EXTRANEOUS MATERIALS THAT ARE HARMFUL TO PLANT GROWTH.
- PLACING MANUFACTURED PLANTING TOPSOIL OVER EXPOSED SUBGRADE:
- 20. TILL SUBGRADE TO A MINIMUM DEPTH OF 12" INCHES. REMOVE STONES LARGER THAN 1-1/2 INCHES IN ANY DIMENSION AND STICKS, ROOTS, RUBBISH, AND OTHER EXTRANEOUS MATTER AND LEGALLY DISPOSE OF THEM OFF OWNER'S PROPERTY.
- 21. APPLY, ADD SOIL AMENDMENTS, AND MIX APPROXIMATELY HALF THE THICKNESS OF TOPSOIL OVER PREPARED, LOOSENED SUBGRADE. MIX THOROUGHLY INTO TOP 4 INCHES OF SUBGRADE. SPREAD REMAINDER OF TOPSOIL.
- 22. SPREAD UNAMENDED SOIL TO TOTAL DEPTH REQUIRED TO MEET FINISH GRADES AFTER NATURAL SETTLEMENT. DO NOT SPREAD IF

- SOIL OR SUBGRADE IS FROZEN, MUDDY, OR EXCESSIVELY WET.
- 23. APPLY AND MIX TOPSOIL IN LIFTS NOT EXCEEDING 8 INCHES IN LOOSE DEPTH FOR MATERIAL COMPACTED BY COMPACTION EQUIPMENT, AND NOT MORE THAN 6 INCHES IN LOOSE DEPTH FOR MATERIAL COMPACTED BY HAND-OPERATED TAMPERS.

PROTECTION:

- 24. IF PLANTING SOIL OR SUBGRADE IS OVERCOMPACTED, DISTURBED, OR CONTAMINATED BY FOREIGN OR DELETERIOUS MATERIALS OR LIQUIDS, REMOVE THE PLANTING SOIL AND CONTAMINATION, RESTORE THE SUBGRADE AS DIRECTED BY LANDSCAPE ARCHITECT AND REPLACE CONTAMINATED PLANTING SOIL WITH NEW PLANTING SOIL.
- 25. REMOVE SURPLUS SOIL AND WASTE MATERIAL INCLUDING EXCESS SUBSOIL, UNSUITABLE MATERIALS, TRASH, AND DEBRIS AND LEGALLY DISPOSE OF THEM OFF OWNER'S PROPERTY UNLESS OTHERWISE INDICATED.

PLANT MATERIAL OBSERVATION:

- 26. LANDSCAPE ARCHITECT MAY OBSERVE PLANT MATERIAL EITHER AT PLACE OF GROWTH OR AT SITE BEFORE PLANTING FOR COMPLIANCE WITH REQUIREMENTS FOR GENUS SPECIES, VARIETY, CULTIVAR, SIZE, AND QUALITY. LANDSCAPE ARCHITECT MAY ALSO OBSERVE TREES AND SHRUBS FURTHER FOR SIZE AND CONDITION OF ROOT SYSTEMS, PESTS, DISEASE SYMPTOMS, INJURIES AND LATENT DEFECTS AND MAY REJECT UNSATISFACTORY OR DEFECTIVE MATERIAL AT ANY TIME DURING PROGRESS OF WORK. REMOVE REJECTED PLANTS IMMEDIATELY FROM PROJECT SITE.
- 27. DO NOT PRUNE TREES AND SHRUBS BEFORE DELIVERY. PROTECT BARK, BRANCHES AND ROOT SYSTEMS FROM SUN SCALD, DRYING, WIND BURN, SWEATING, WHIPPING, AND OTHER HANDLING AND TYING DAMAGE. PROVIDE PROTECTIVE COVERING OF PLANTS DURING SHIPPING AND DELIVERY.

PREPARATION:

- 28. PROTECT STRUCTURES, UTILITIES, SIDEWALKS, PAVEMENTS, AND OTHER FACILITIES AND TURF AREAS AND EXISTING PLANTS FROM DAMAGE CAUSED BY PLANTING OPERATIONS.
- 29. LAYOUT PLANTS AT LOCATIONS DIRECTED BY PLAN. STAKE LOCATIONS OF INDIVIDUAL TREES AND SHRUBS AND OUTLINE AREAS FOR MULTIPLE PLANTINGS.
- 30. DELIVERY: DELIVER PLANTS AFTER PREPARATIONS FOR PLANTING HAVE BEEN COMPLETED AND INSTALL IMMEDIATELY. IF PLANTING IS DELAYED MORE THAN SIX HOURS AFTER DELIVERY, SET PLANTS AND TREES IN THEIR APPROPRIATE ASPECT (SUN, FILTERED SUN, OR SHADE), PROTECT FROM WEATHER AND MECHANICAL DAMAGE, AND KEEP ROOTS MOIST.
- 31. FIELD CONDITIONS: VERIFY ACTUAL GRADE ELEVATIONS, SERVICE AND UTILITY LOCATIONS, IRRIGATION SYSTEM COMPONENTS, AND DIMENSIONS OF PLANTINGS AND CONSTRUCTION CONTIGUOUS WITH NEW PLANTINGS BY FIELD MEASUREMENTS BEFORE PROCEEDING WITH PLANTING WORK.
- 32. PLANT MATERIAL: FURNISH NURSERY GROWN PLANTS TRUE TO GENUS, SPECIES, VARIETY, CULTIVARS, STEM FORM, SHEARING, AND OTHER FEATURES INDICATED ON PLANT SCHEDULE WITH HEALTHY ROOT SYSTEMS DEVELOPED BY TRANSPLANTING OR ROOT PRUNING. PROVIDE WELL-SHAPED, FULL-BRANCHED, HEALTHY, VIGOROUS STOCK, DENSELY FOLIATED WHEN IN LEAF AND FREE OF DISEASE, PESTS, EGGS, LARVAE AND DEFECTS SUCH AS KNOTS, SUN SCALD, INJURIES, ABRASIONS AND DISFIGUREMENT.
- 33. PRUNING: PRUNE, THIN, AND SHAPE TREES, SHRUBS AND VINES AS DIRECTED BY LANDSCAPE ARCHITECT.
- 34. LABELING: LABEL AT LEAST ONE PLANT OF EACH VARIETY, SIZE, AND CALIPER WITH A SECURELY ATTACHED, WATERPROOF TAG BEARING LEGIBLE DESIGNATION OF COMMON NAME AND FULL SCIENTIFIC NAME, INCLUDING GENUS AND SPECIES.
- 35. IF FORMAL ARRANGEMENTS OR CONSECUTIVE ORDER OF PLANTS IS INDICATED ON THE THE DRAWINGS. SELECT STOCK FOR UNIFORM HEIGHT AND SPREAD, AND NUMBER THE LABELS TO ASSURE SYMMETRY IN PLANTING.

PLANTING:

- 36. SET OUT AND SPACE GROUND COVER AND PLANTS OTHER THAN TREES, SHRUBS AND VINES AS INDICATED ON DRAWINGS IN EVEN ROWS WITH TRIANGULAR SPACING.
- 37. USE PLANTING SOIL FOR BACKFILL
- 38. DIG HOLES LARGE ENOUGH TO ALLOW SPREADING OF ROOTS.
- 39. WATER THOROUGHLY AFTER PLANTING, TAKING CARE NOT TO COVER PLANT CROWNS WITH WET SOIL.
- 40. PROTECT PLANTS FROM HOT SUN AND WIND; REMOVE PROTECTION IF PLANTS SHOW EVIDENCE OF RECOVERY FROM TRANSPLANTING SHOCK.

REPAIR AND REPLACEMENT:

41. REPAIR OR REPLACE EXISTING OR NEW TREES AND OTHER PLANTS THAT ARE DAMAGED BY CONSTRUCTION OPERATIONS, IN A MANNER APPROVED BY LANDSCAPE ARCHITECT.

CLEANING AND PROTECTION:

- 42. DURING PLANTING, KEEP ADJACENT PAVING AND CONSTRUCTION CLEAN AND WORK AREA IN AN ORDERLY CONDITION.
- 43. REMOVE SURPLUS SOIL AND WASTE MATERIAL INCLUDING EXCESS SUBSOIL, UNSUITABLE SOIL, TRASH, AND DEBRIS AND LEGALLY DISPOSE OF THEM OFF OWNER'S PROPERTY.
- 44. PROTECT PLANTS FROM DAMAGE DUE TO LANDSCAPE OPERATIONS AND OPERATIONS OF OTHER CONTRACTORS AND TRADES. MAINTAIN PROTECTION DURING INSTALLATION AND MAINTENANCE PERIODS.
- 45. AFTER INSTALLATION AND BEFORE SUBSTANTIAL COMPLETION, REMOVE NURSERY TAGS, NURSERY STAKES, TIE TAPE, WIRE, BURLAP, AND OTHER DEBRIS FROM PLANT MATERIAL, PLANTING AREAS, AND PROJECT SITE.

MAINTENANCE SERVICE:

46. LANDSCAPE CONTRACTOR SHALL PROVIDE MAINTENANCE BY SKILLED EMPLOYEES OF LANDSCAPE INSTALLER AND MAINTAIN THE PLANT MATERIAL, IRRIGATION SYSTEM AND KEEP PLANTED AREAS WEED FREE. BEGIN MAINTENANCE IMMEDIATELY AFTER PLANTS ARE INSTALLED AND CONTINUE UNTIL PLANTINGS ARE ACCEPTABLY HEALTHY AND WELL ESTABLISHED AND THROUGHOUT WARRANTY PERIOD.

WARRANTY:

47. INSTALLER AGREES TO REPAIR OR REPLACE PLANTINGS AND ACCESSORIES THAT FAIL IN MATERIALS, WORKMANSHIP, OR GROWTH WITHIN SPECIFIED WARRANTY PERIOD. WARRANTY PERIOD TO BE FOR 12 MONTHS FROM DATE OF UNTIL FINAL ACCEPTANCE IS RECEIVED IN WRITING FROM THE OWNERS REPRESENTATIVE.





1200 6th Avenue, Suite1620, Seattle, WA 98101 206.267.2425 TEL 206.267.2429 FAX www.ahbl.com WEB

Project Title:

BRIDGE POINT SEATAC 300

BRIDGE DEVELOPMENT PARTNERS, LLC

10655 NE 4TH STREET, SUITE 500 BELLEVUE, WA 98004 KYLE SIEKAWITCH PH: (425) 749-4325

Project No.


2200531.40

Issue Set & Date:

SITE DEVELOPMENT **PERMIT SET**

03/11/22



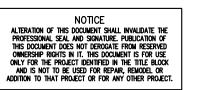

REVISED 06/06/2022 SEPA RESPONSES

REVISED 02/25/2022 SEPA RESPONSES

REVISED 01/21/2022 PER CITY OF SEATAC COMMENTS DATED 01/14/2022

REVISED 10/11/2021 PER CITY OF SEATAC COMMENTS DATED 9/3/2021

REVISED 7/16/2021 PER CITY OF SEATAC COMMENTS DATED 5/28/2021

Sheet Title:

PLANTING SPECIFICATIONS

Designed by: MS

Drawn by: HS/EH/SW

Sheet No.